

# The Banksia - Granny Flat

## for HPG

223 MORRIS ROAD ROTHWELL QLD 4022



Rev	Description	Date
07	The Banksia - Presentation Issue	6/08/2020
08	Preliminary	21/09/2020

Figured dimensions take precedence over scale dimensions. Contractors must verify all dimensions on site before commencing any work or making shop drawings.


project  
**The Banksia - Granny Flat**  
223 MORRIS ROAD ROTHWELL QLD 4022

Titlepage  
scale: @ A3

WD  
architect: GA  
drawn: PN

project no: 0575-03

**A-WD-00.01 08**

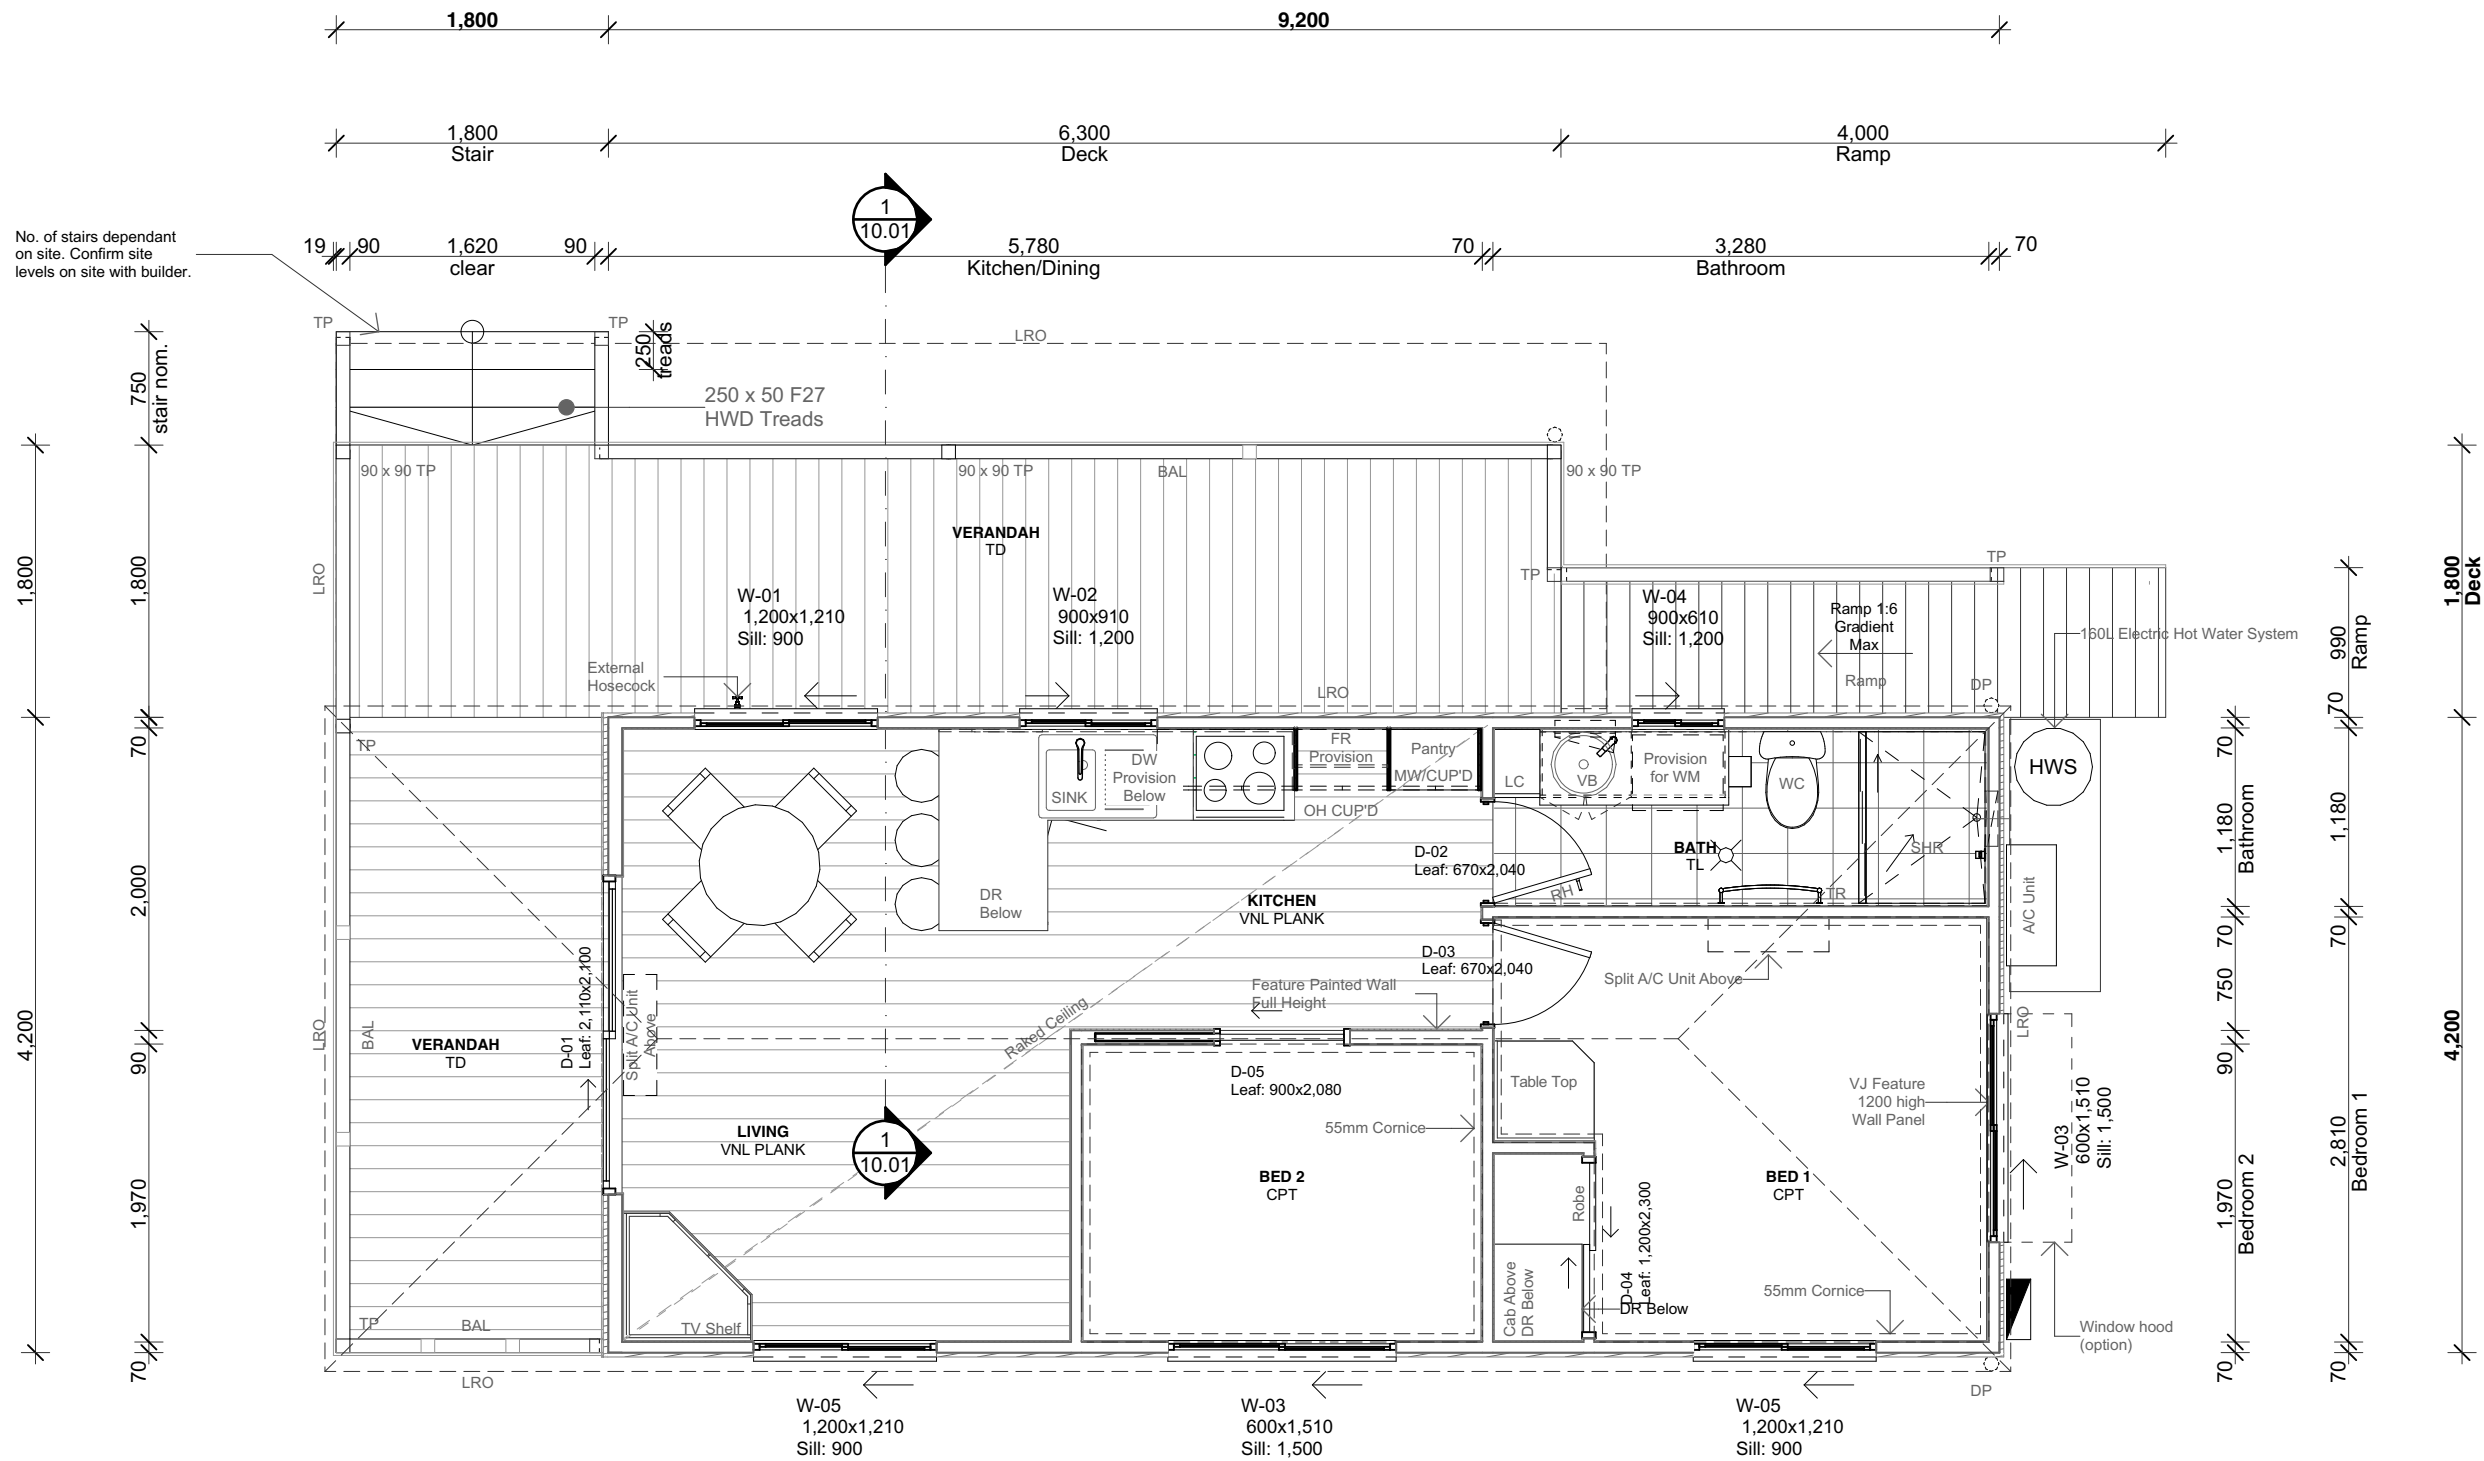

FLOOR PLAN LEGEND

- Door Number
- Window Number
- Al. Post Aluminium Post  
BAL Aluminium RHS Frame  
DP Downpipe  
DR Drawer  
DW Dishwasher  
FGW Floor Grate Waste  
FR Fridge  
LC Linen Closet  
LRO Line of Roof Over  
RH Robe Hook  
SHR Shower  
TP Timber Post  
TR Towel Rail  
VB Vanity Basin  
WC Water Closet

- NOTES
- To be read in conjunction with any consultants documentation if provided.
  - Dimensions are taken to wall cores and do not include linings.
  - Provide falls to all Wet Areas to AS.3740

FRAMING PLAN LEGEND

MATERIALS & FINISHES

- CPT Carpet  
TD Timber Deck  
TL Tile

- NOTES
- Refer to schedules for material information.

AREA CALCULATIONS

LIVING AREA = 38.6m<sup>2</sup>  
VERANDAH = 22m<sup>2</sup>

TOTAL = 60.6m<sup>2</sup>

NOTE:  
Current plan represents as built display model  
Alternative Deck Option 1 - No Verandah  
Alternative Deck Option 2 - Verandah Extension

Rev	Description	Date
15	Preliminary	21/09/2020
16	Preliminary	6/10/2020


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ELEVATION & SECTION LEGEND

CLD	Cladding type
DP	Downpipe
EG	Eaves Gutter
HR	Aluminium Handrail
MRS	Metal Roof Sheet


NOTES

1. Provide insulation and building paper to all external walls as per energy efficiency report.
2. Refer to manufacturer specification for full product details, fixing details and warranties.
3. Refer to schedules for material information.

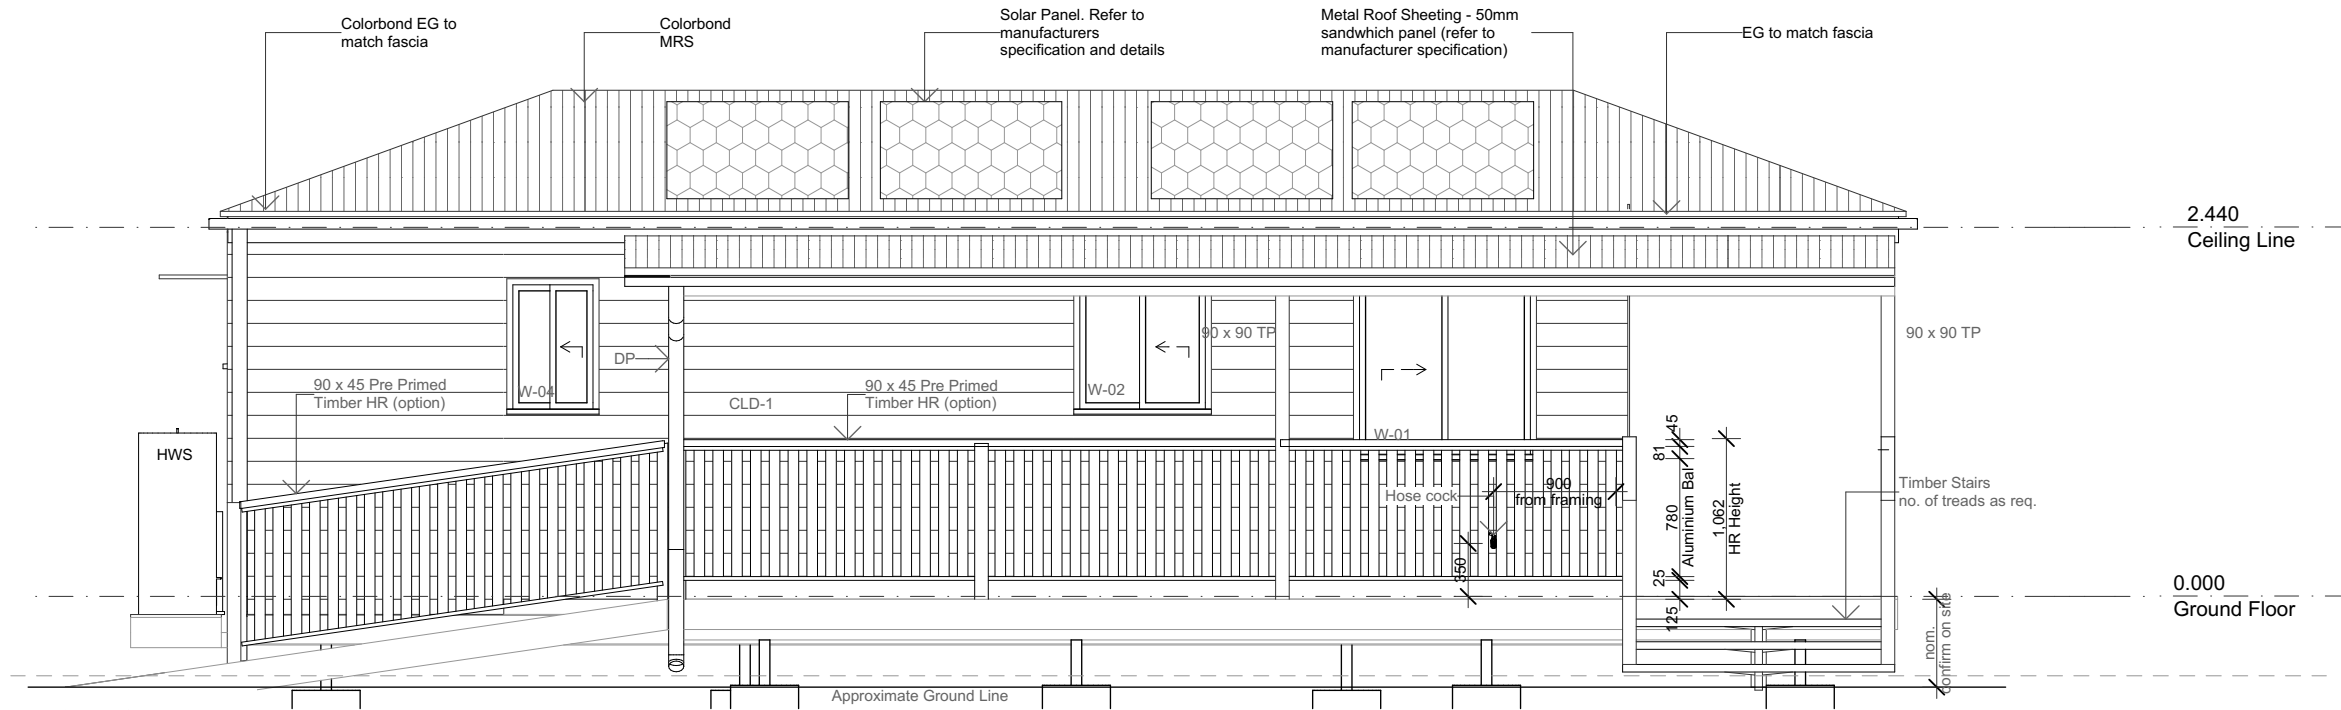

1 North Elevation

Scale 1:50

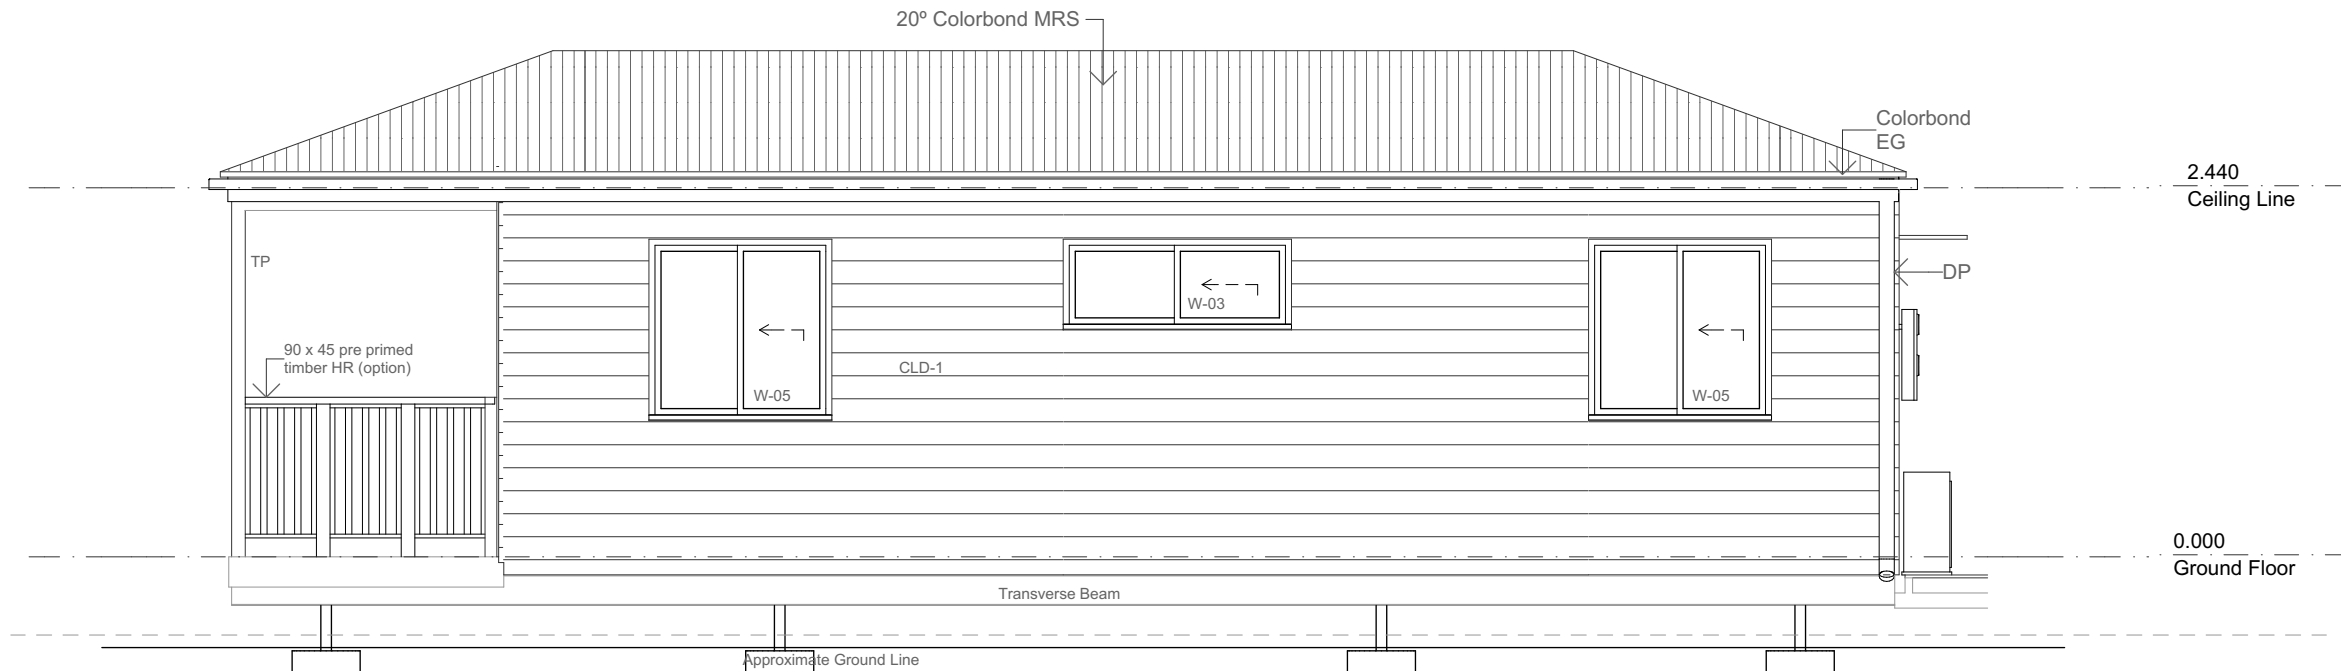

2 South Elevation

Scale 1:50

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11	The Banksia - Presentation Issue	6/08/2020
12	Preliminary	21/09/2020

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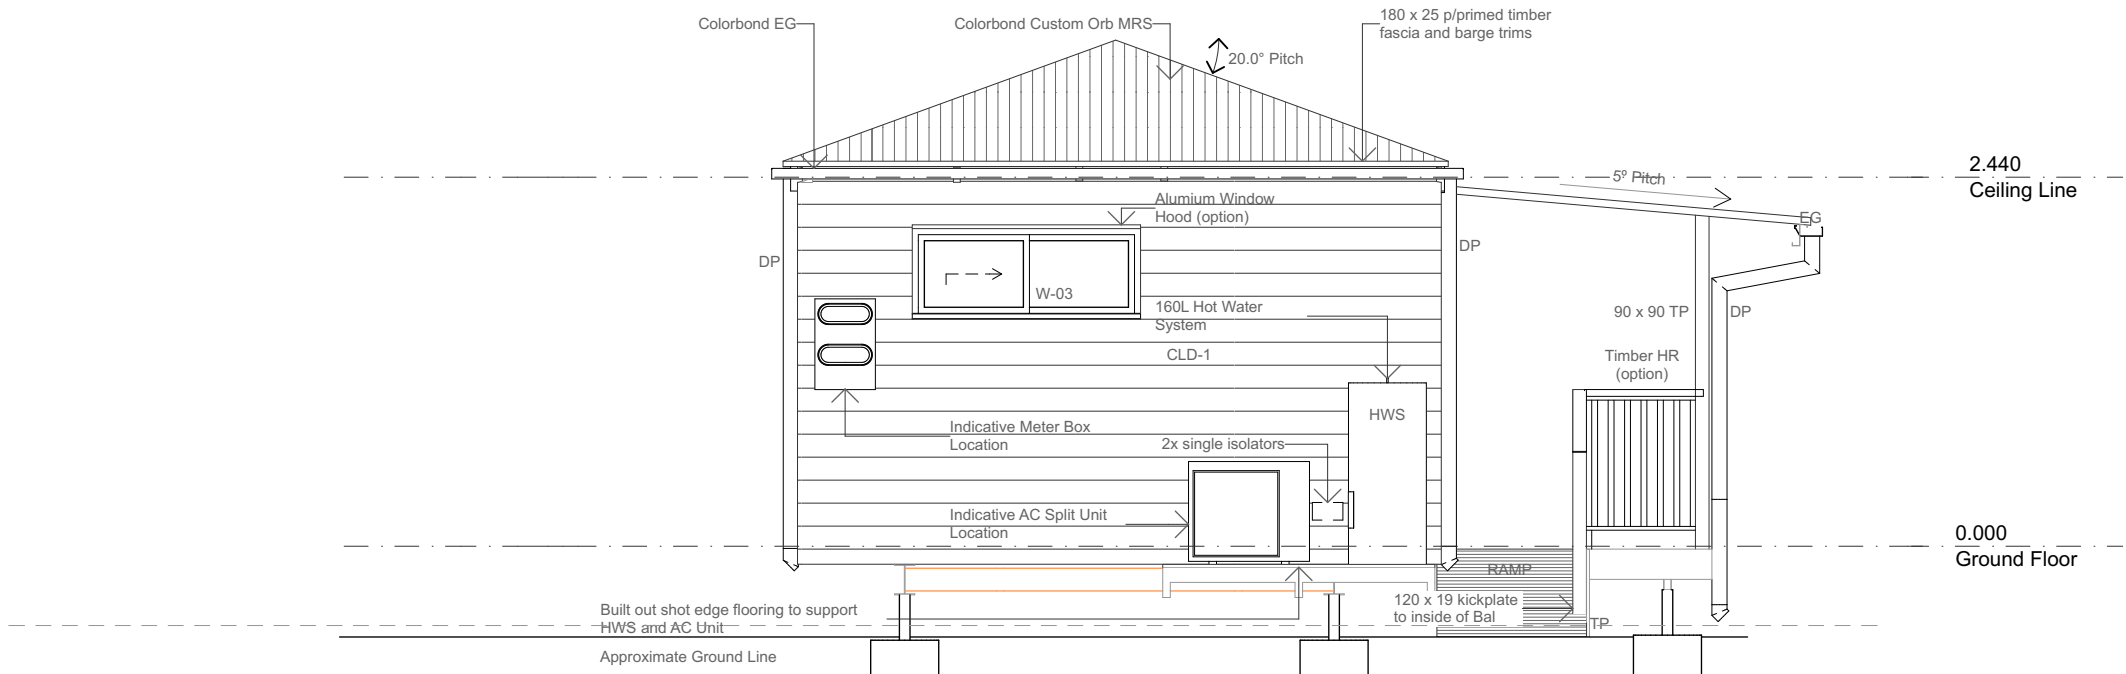


ELEVATION & SECTION LEGEND

CLD	Cladding type
DP	Downpipe
EG	Eaves Gutter
HR	Aluminium Handrail
MRS	Metal Roof Sheet


NOTES

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2 East Elevation

Scale 1:50



1 West Elevation

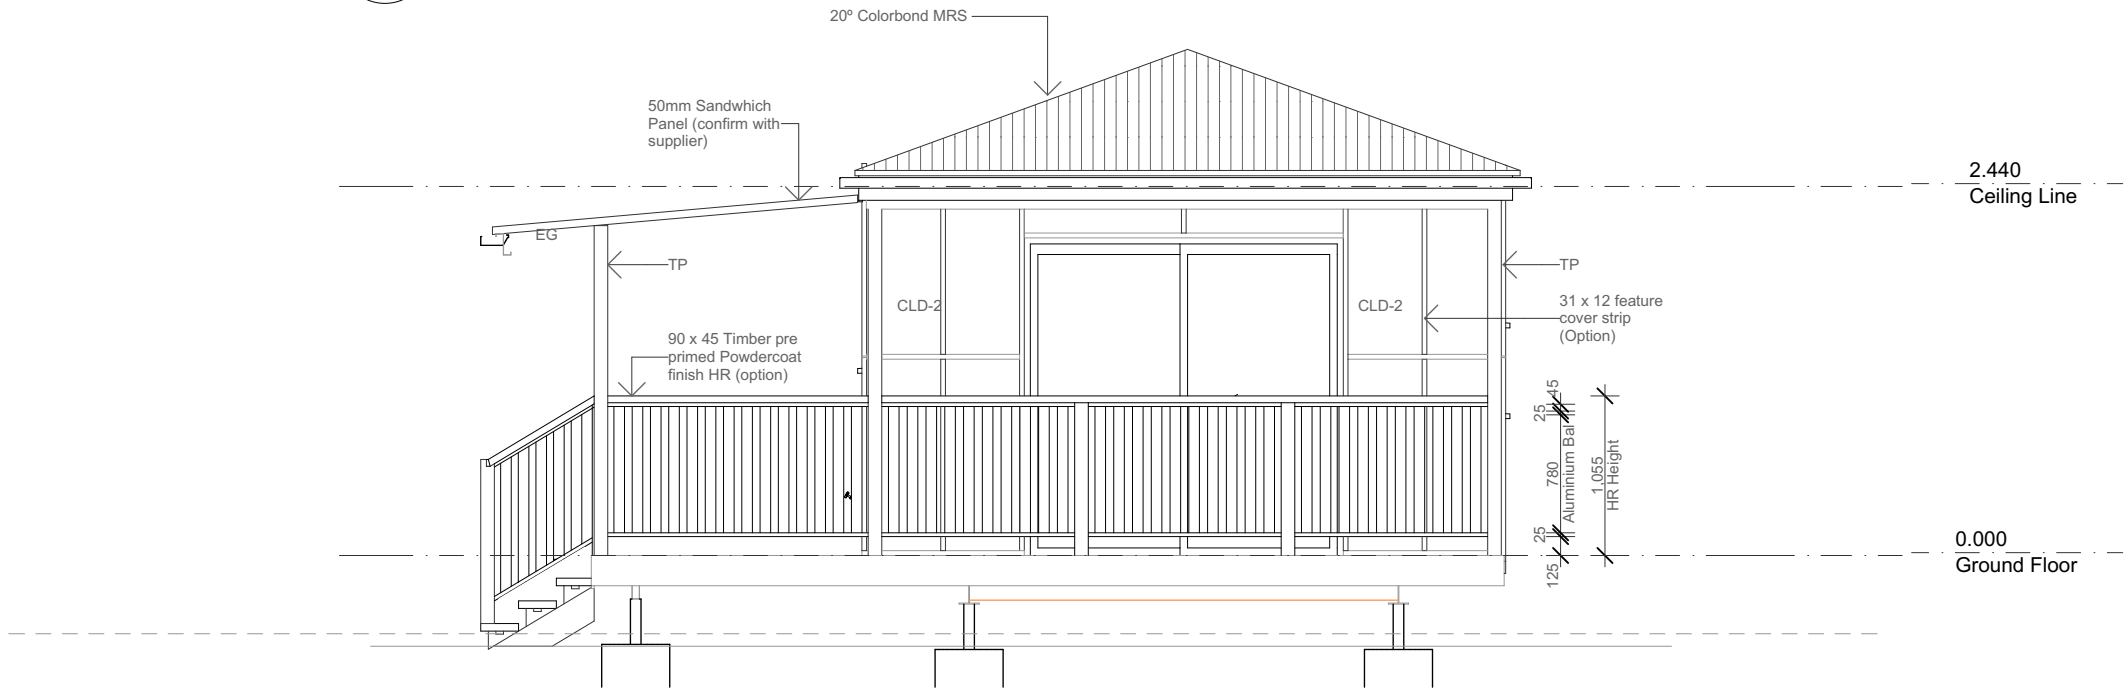Scale 1:50

Rev	Description	Date
05	The Banksia - Presentation Issue	6/08/2020
06	Preliminary	21/09/2020

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project

The Banksia - Granny Flat

223 MORRIS ROAD ROTHWELL QLD 4022

Elevations

scale: 1:50 @ A3

WD

architect:

GA

drawn:

PN

project no: 0575-03

A-WD-09.02

06

LIGHTING LEGEND


- Switch
- Switch - two way
- Switch with dimmer - option
- Switch with fan control
- Recessed LED light
- Wall light - surface mounted
- Electrical meterboard
- Extractor fan with light
- LED round oyster light (kitchen)

ELECTRICAL LEGEND

- GPO - single
- GPO - double
- GPO - ext weatherproof
- TV socket
- Phone socket
- Smoke detector
- Hot Water System 160L/250L

NOTES:

- All LED light fittings are to be warm-white no more than 3000 kelvin.

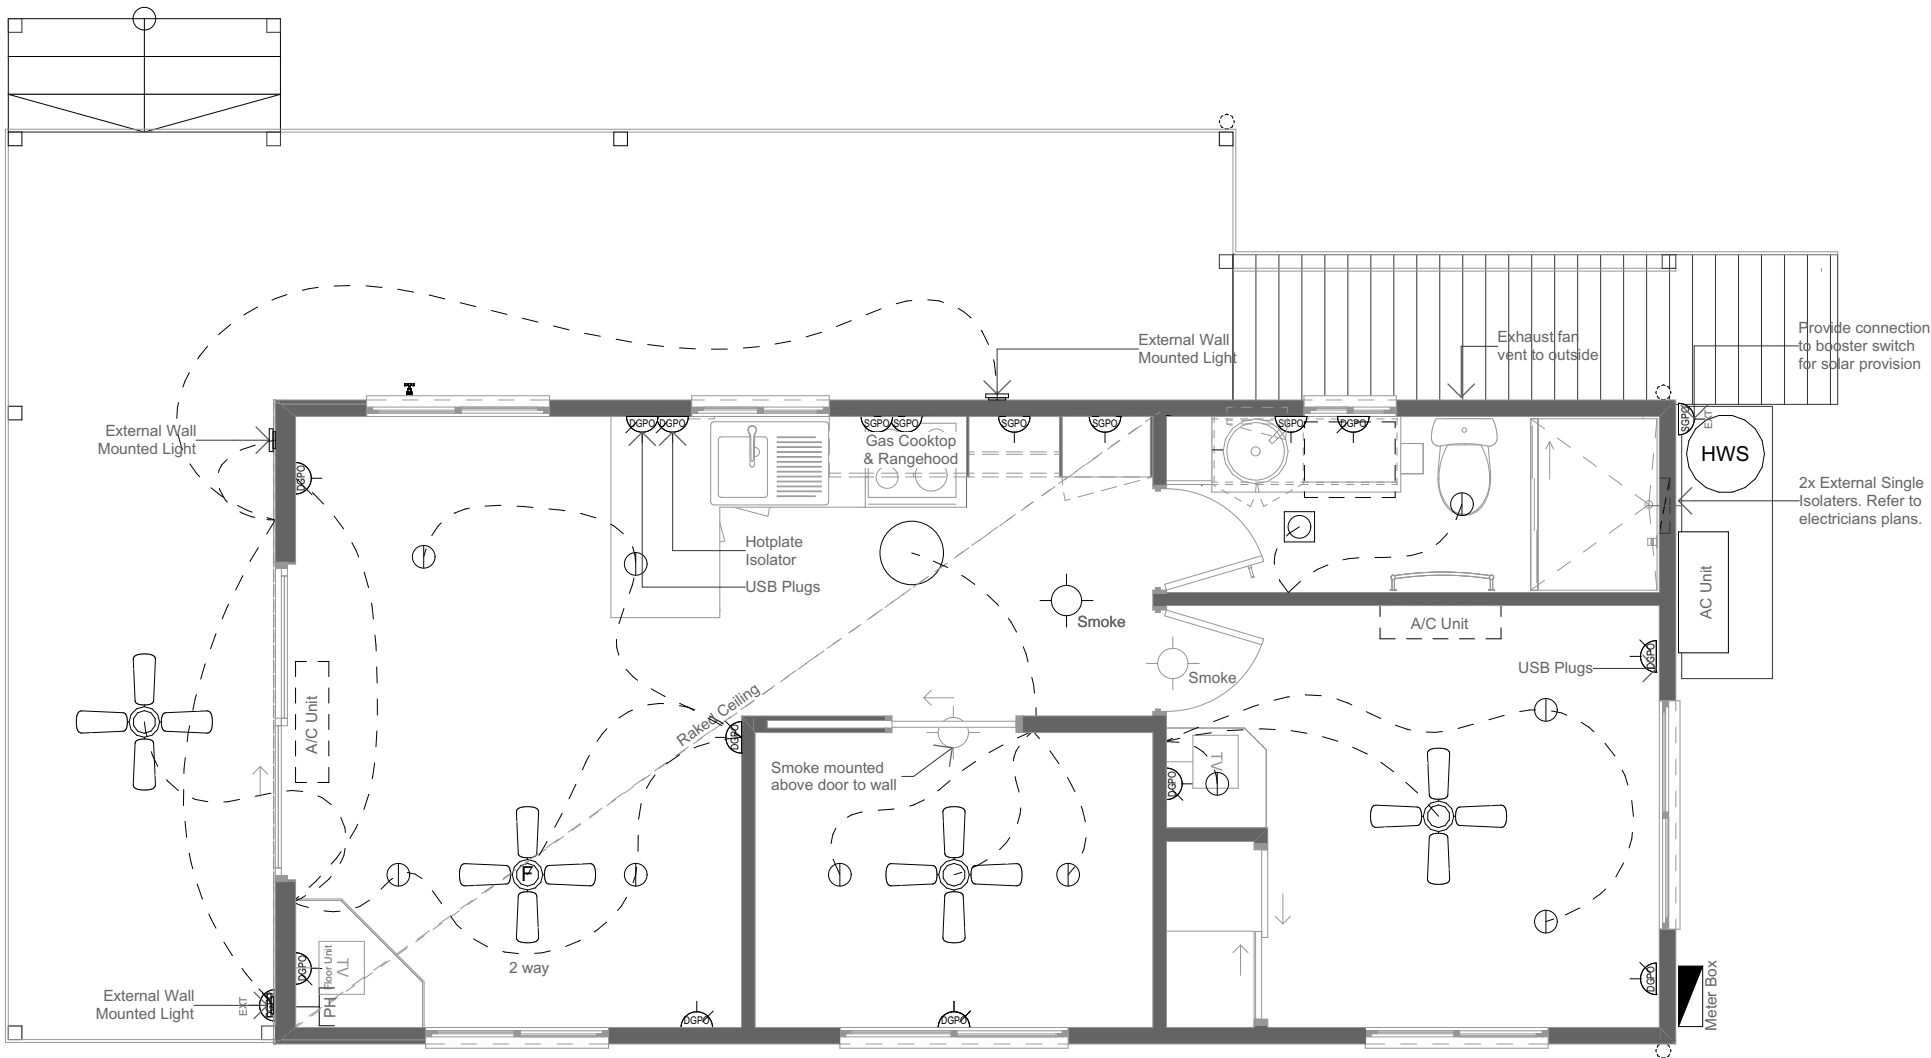

Electrical Plan - Ground Floor

scale: 1:50 @ A3

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10	The Banksia - Presentation Issue	6/08/2020
11	Preliminary	21/09/2020


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BRACING PLAN LEGEND

Bracing Plywood to Wall


NOTES

- 1. Refer to eng specifications and details for tie down details and fixing details
- 2. All Member sizes to be reviewed and confirmed by engineer

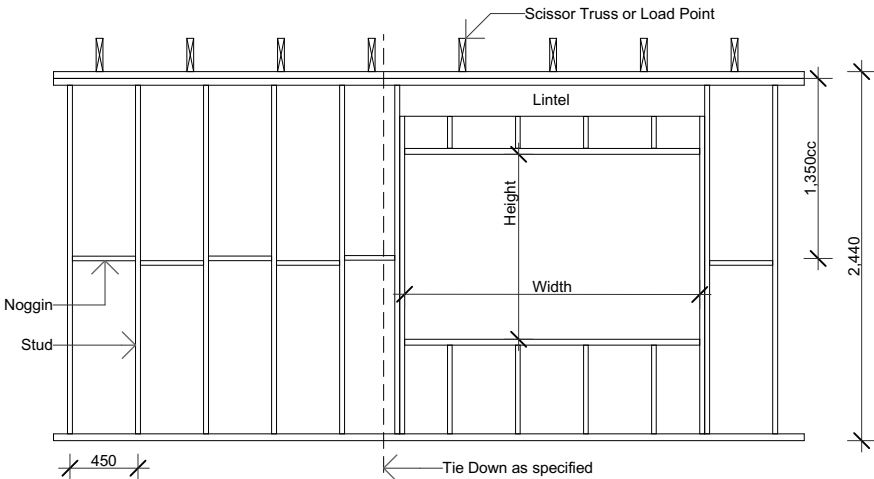

2 Typical Load-Bearing Timber Wall Frame

Scale 1:50

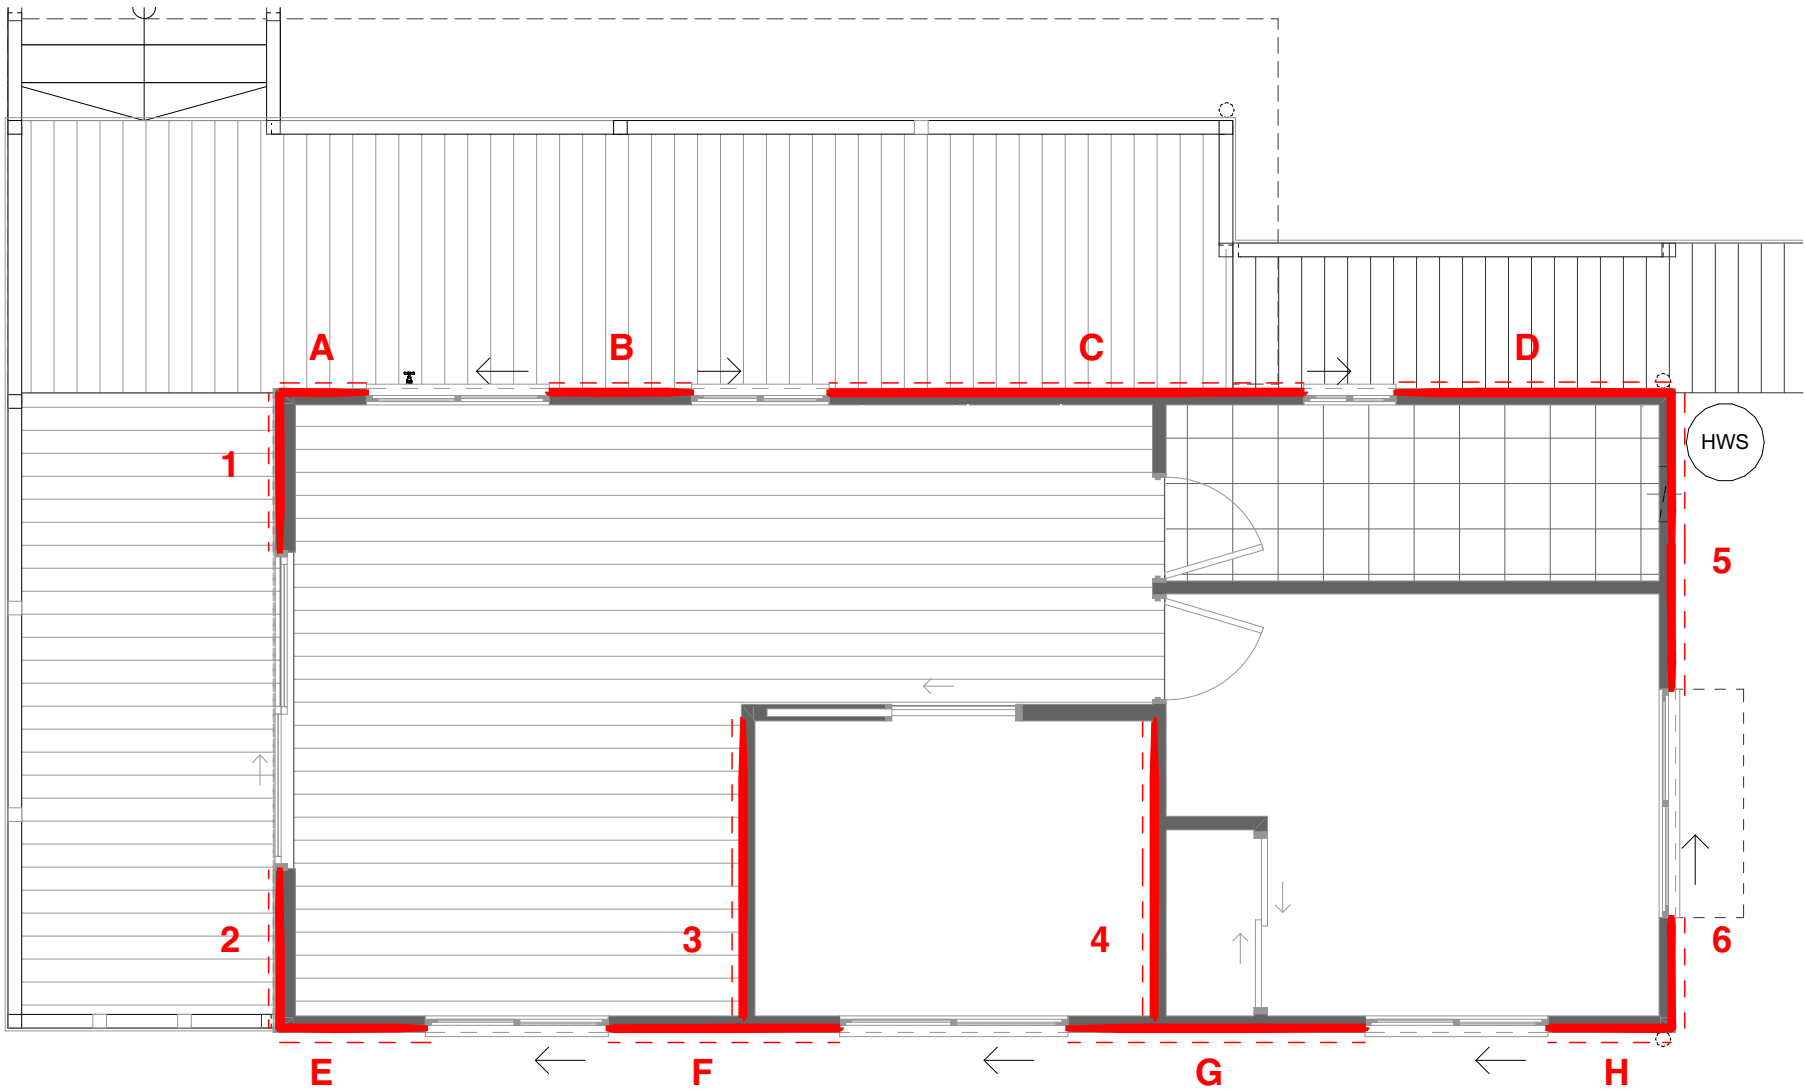

1 Bracing Plan

Scale 1:50

WALL FRAMING SCHEDULE

MEMBER	TOP PLATE (DOUBLE)	COMMON STUDS	BOTTOM PLATE
EXTERNAL WALLS (unless stated otherwise)	2/70 X 35 MGP10	70 X 35 MGP10 @450cc	70 X 35 MGP10
INT. LOAD BEARING WALLS	2/70 X 35 MGP10	70 X 35 MGP10 @450cc	70 X 35 MGP10
INT. NON LOAD BEARING WALLS	2/70 X 35 MGP10	70 X 35 MGP10 @450cc	70 X 35 MGP10

NOTE:

- All internal timber framing to be LOSP H2 treated.
- 35mm Wall thickness nogging to be provided @ 1350crs max. of all walls.
- All external timber framing to be LOSP H3 treated.
- Bracing Schedule to be designed in accordancew with AS 1684.2 - Latest Edition

3.4kN/m Bracing System

Minimum Plywood Thickness (mm)	4.0mm
Stress Grade	F22
Stud Spacing	450 cc
Fixings	30x2.8mm dia flathead nails

BRACING SCHEDULE

WIND BRACING N3					
direction 'X' (left/right) f =			direction 'Y' up/down) f =		
WALL	TYPE & LENGTH (in m)	RESISTANCE (in Kn's)	WALL	TYPE & LENGTH (in m)	RESISTANCE (in Kn's)
A	0.57PLY	1.938	1	1.045PLY	3.553
B	0.94PLY	3.196	2	1.05PLY	3.57
C	3.14PLY	10.676	3	1.97PLY	6.698
D	1.85PLY	6.29	4	1.97PLY	6.698
E	0.96PLY	3.264	5	1.96PLY	6.681
F	1.53PLY	5.202	6	0.73PLY	2.482
G	1.965PLY	6.681			
H	0.815PLY	2.771			
Bracing Required in Direction X is 8.2Kn			Bracing Required in Direction Y is 24.5Kn		
Bracing Placed in Direction X is 40.018Kn			Bracing Placed in Direction Y is 29.682Kn		

NOTE:


- Plywood butt joint to be at a common stud with clouts as crs. shown.
- Horizontal butt joints to be fixed to nogging at 150 crs.
- Allow to pack out adjacent studs with continuous strips of ply to receive wall lining.

Typical Bracing and Wall Framing Details


scale: @ A3

FC	Fibre Cement
RHS	Rectangular Hollow Section
UB	Universal Beam


1. To be read in conjunction with engineering documentation if provided.
2. For UB sizes refer to eng documentation.
3. Note that UB Bearer spacing might differ based on UB size. Refer to eng documentation.
4. Flooring substructure to be 22mm or 19mm Nexen or similar approved FC

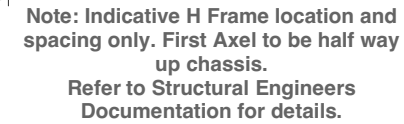

Scale 1:50

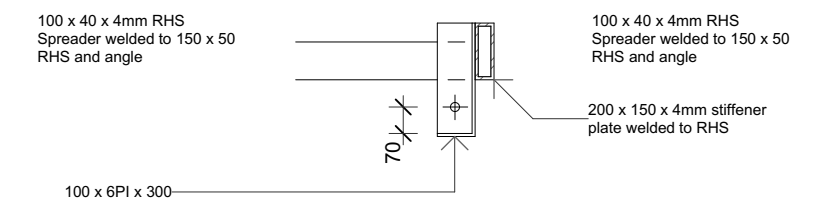

Scale 1:20

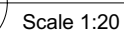

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223 MORRIS ROAD ROTHWELL QLD 4022

scale: @ A3




**A-WD-02.02**

ELEVATION & SECTION LEGEND


CLD Cladding type  
DP Downpipe  
EG Eaves Gutter  
HR Aluminium Handrail  
MRS Metal Roof Sheet

NOTES

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2. Refer to manufacturer specification for full product details, fixing details and warranties.
3. Refer to schedules for material information.

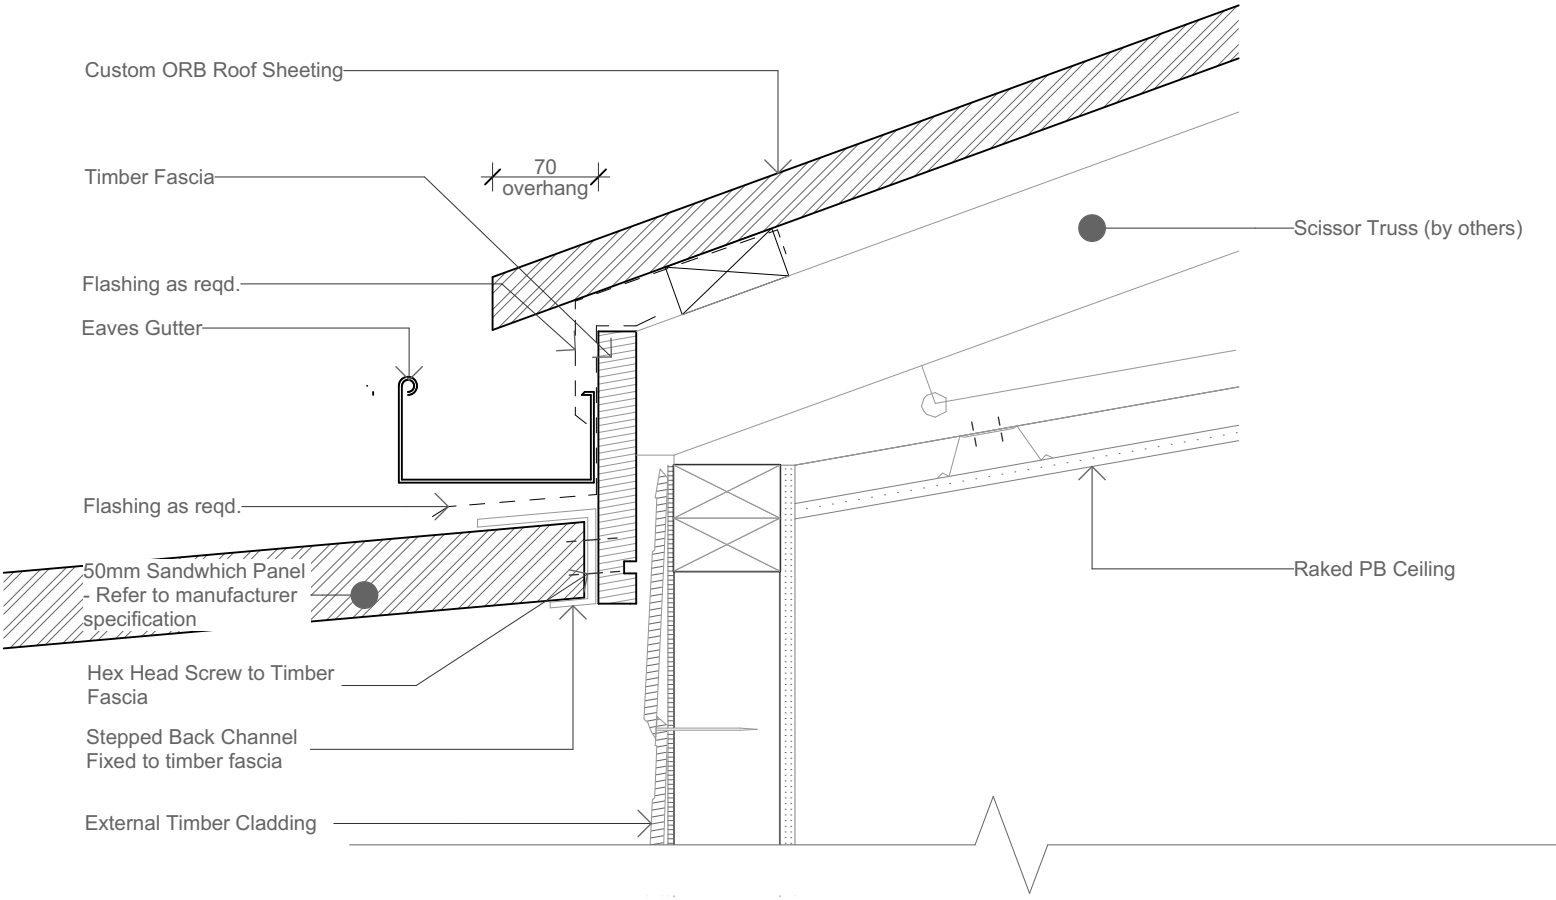


1 D-01 Detail  
- Scale 1:5

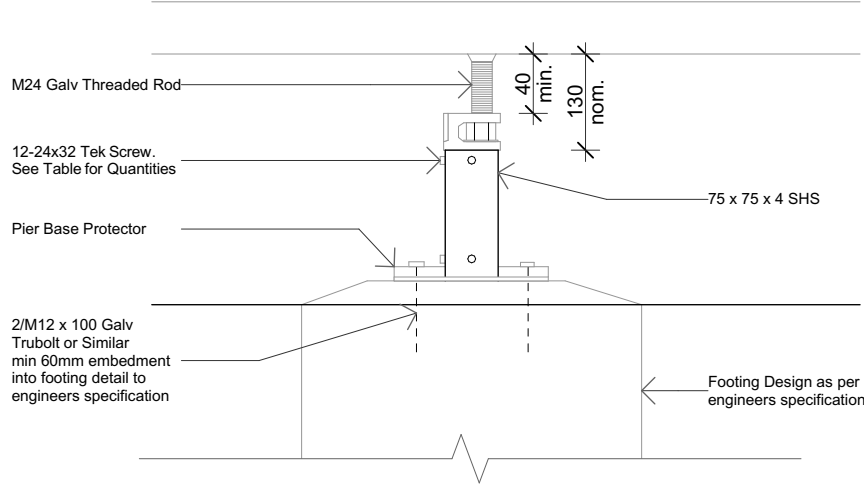


2 D-02 Detail  
- Scale 1:10

Tek Screw Qty	Max Uplift Capacity kN
6	27.0
4	19.2
4	16.2
3	10.8
2	9.6

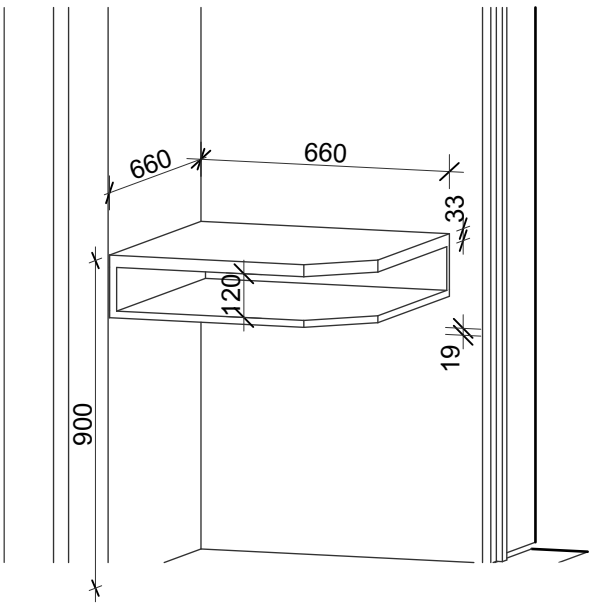

Bedroom Table Detail

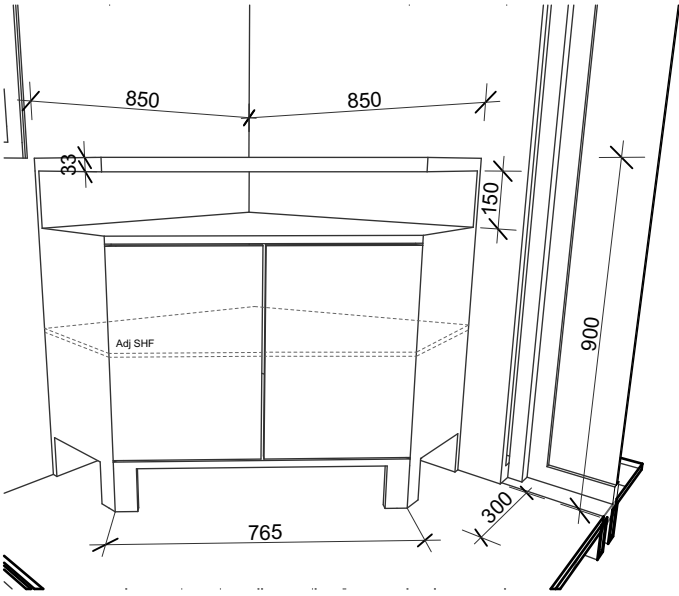

TV Unit Detail


Rev	Description	Date
03	The Banksia - Review Issue	23/07/2020
04	Preliminary	21/09/2020

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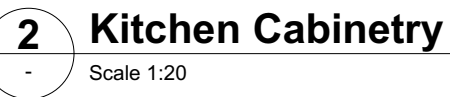


CAB	Cabinet
CKT	Cooktop
DW	Dishwasher
DR	Drawer
OV	Oven - under bench
RH	Robe Hook
SB	Splashback
SNK	Sink
STO	Stone Benchtop
TL	Tile
TRH	Toilet Roll Holder
LAM	Laminate

1. All floor tiles in wet areas to fall between 1:80 and 1:100 where applicable.
2. Allow for power and/or water supply and drainage for DW, FR and WM.
3. Handle pull to bottom cabinets. Push mechanism to top cabinets. Soft closing mechanism to all cabinets.
4. It is the joiners responsibility to ensure the structural integrity and fitness-for-use of all joinery items.
5. Ensure that Heavy Duty Moisture Resistant substrate is used on all wet area joinery, or joinery that is otherwise adjacent to wet areas.
6. It is the joiners responsibility to confirm all dimensions on site prior to ordering/manufacturing all joinery items.
7. Read in conjunction with consultant documents for details relating to (but not limited to) vents, power points, data points, tundishes, floor wastes and water supply.
8. Shower floor waste to be full length stainless steel grate channel. Fall Shower floor to waste.
9. Ensure that Heavy Duty Moisture Resistant substrate (ie: Villaboard 6mm) is used on all wet area joinery, or joinery that is otherwise adjacent to wet areas.

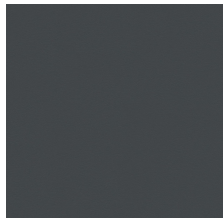

LAM-2  
Laminex Black Matte or  
similar approved



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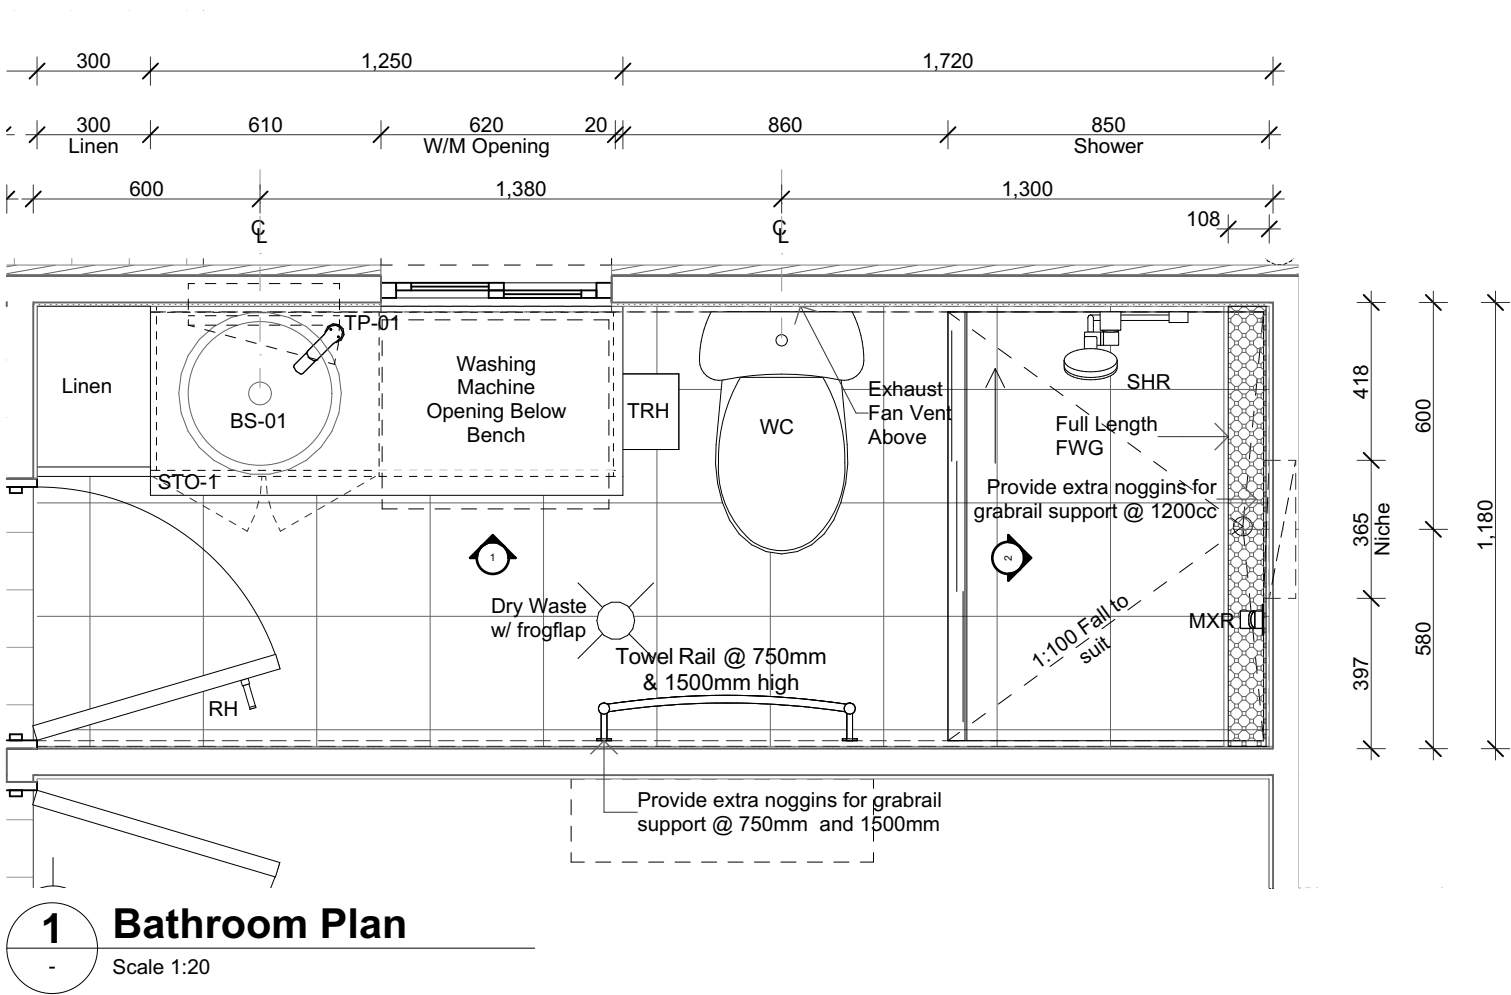
**A-WD-15.01**                      **11**

JOINERY LEGEND

CAB Cabinet  
CKT Cooktop  
DW Dishwasher  
DR Drawer  
OV Oven - under bench  
RH Robe Hook  
SB Splashback  
SNK Sink  
STO Stone Benchtop  
TL Tile  
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LAM Laminate

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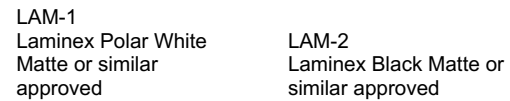


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10	The Banksia - Presentation Issue	6/08/2020
11	Preliminary	21/09/2020

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CKT	Cooktop
DW	Dishwasher
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FLOOR PLAN LEGEND


- 008

Door Number
- W 04

Window Number
- Al. Post Aluminium Post
- BAL Aluminium RHS Frame
- DP Downpipe
- DR Drawer
- DW Dishwasher
- FGW Floor Grate Waste
- FR Fridge
- LC Linen Closet
- LRO Line of Roof Over
- RH Robe Hook
- SHR Shower
- TP Timber Post
- TR Towel Rail
- VB Vanity Basin
- WC Water Closet

NOTES

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2. Dimensions are taken to wall cores and do not include linings.
3. Provide falls to all Wet Areas to AS.3740

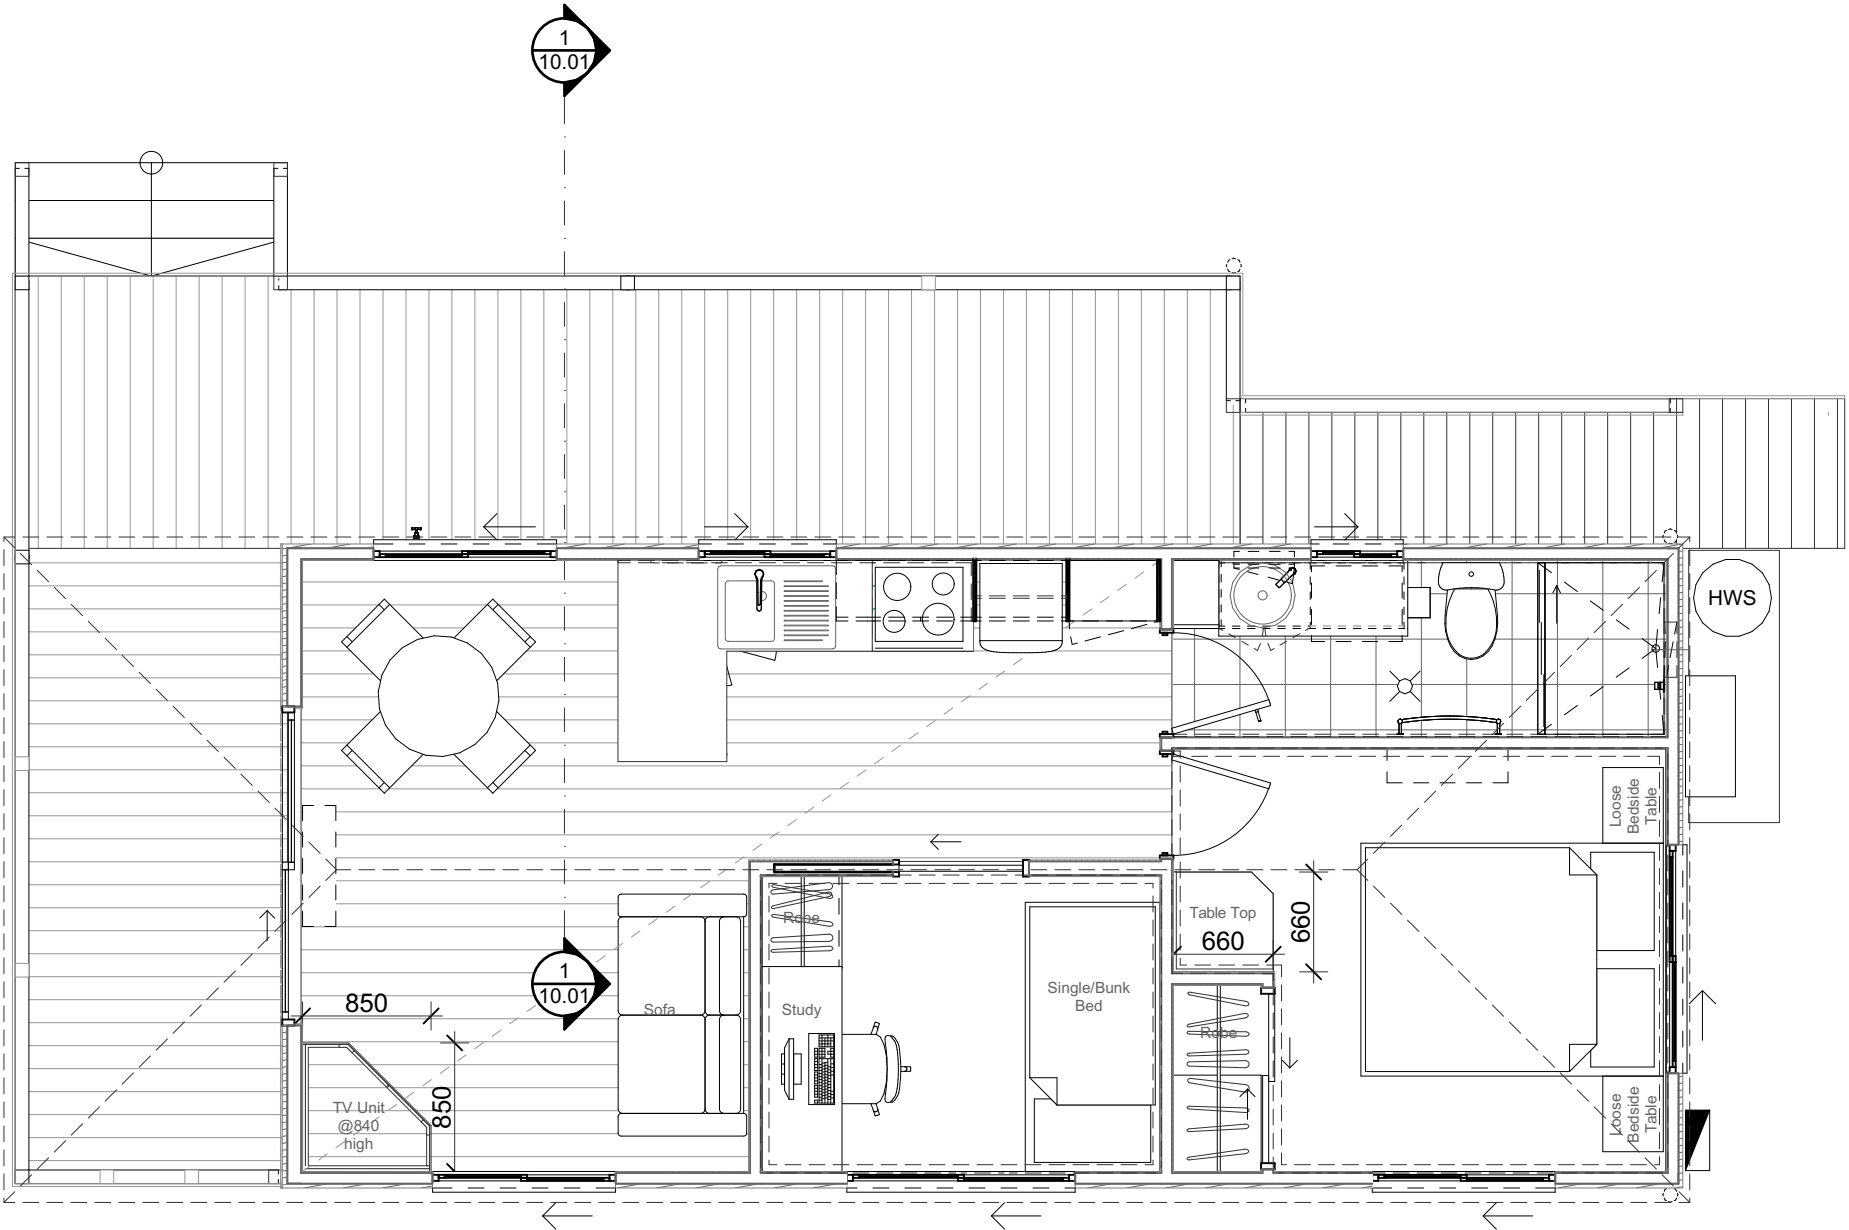

Furniture Plan  
scale: 1:50 @ A3

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project  
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223 MORRIS ROAD ROTHWELL QLD 4022



WD  
architect: GA  
drawn: PN

project no: 0575-03


**A-WD-03.02** **08**

ELEVATION & SECTION LEGEND

CLD Cladding type  
DP Downpipe  
EG Eaves Gutter  
HR Aluminium Handrail  
MRS Metal Roof Sheet

NOTES

1. Provide insulation and building paper to all external walls as per energy efficiency report.
2. Refer to manufacturer specification for full product details, fixing details and warranties.
3. Refer to schedules for material information.

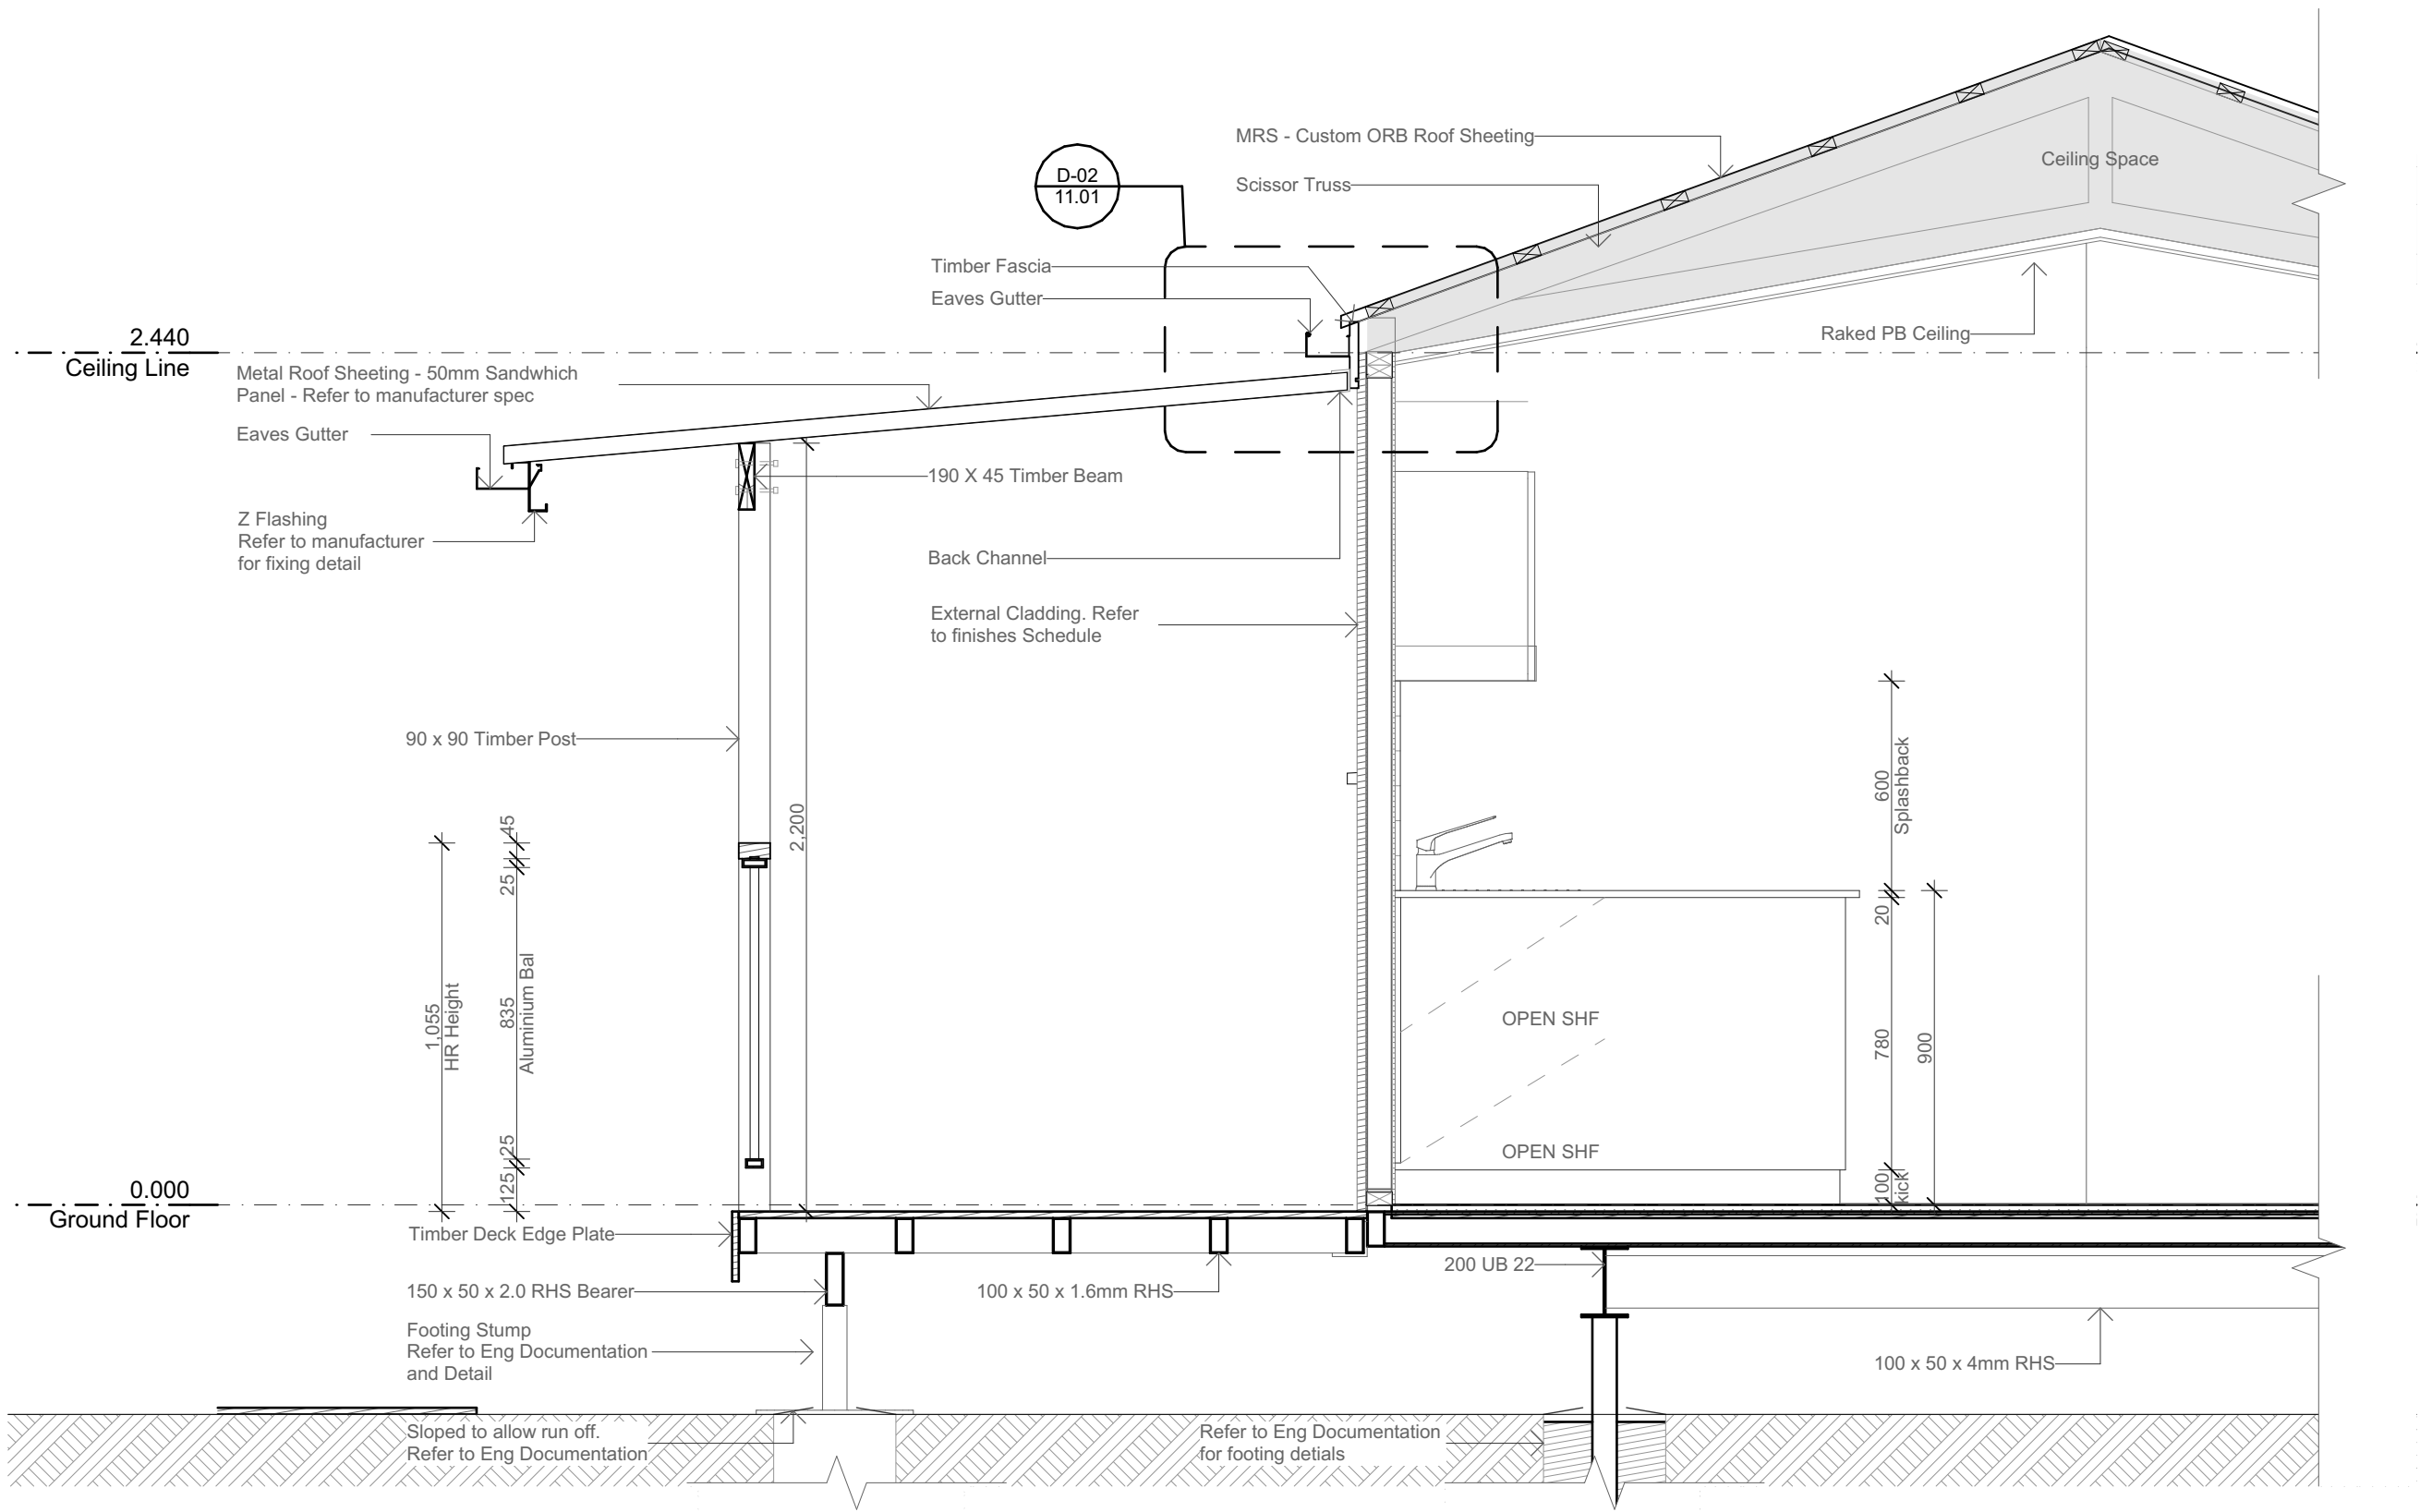

1 A Section A  
Scale 1:20

Section 1  
scale: @ A3

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04	The Banksia - Presentation Issue	6/08/2020
05	Preliminary	21/09/2020

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WD  
architect: GA  
drawn: PN

project no: 0575-03

A-WD-10.01 05




ROOF LEGEND

BC Barge Cap  
DP Downpipe  
EG Eaves Gutter  
HC Hip Capping  
LBB Line of Building Below  
RC Ridge Capping  
MRS Metal Roof Sheet

NOTES

1. Refer to truss manufacturer details for full truss layout and specification.
2. Refer to specification for full product details and warranties.
3. Scribe flashings and cappings to roof sheet profile.

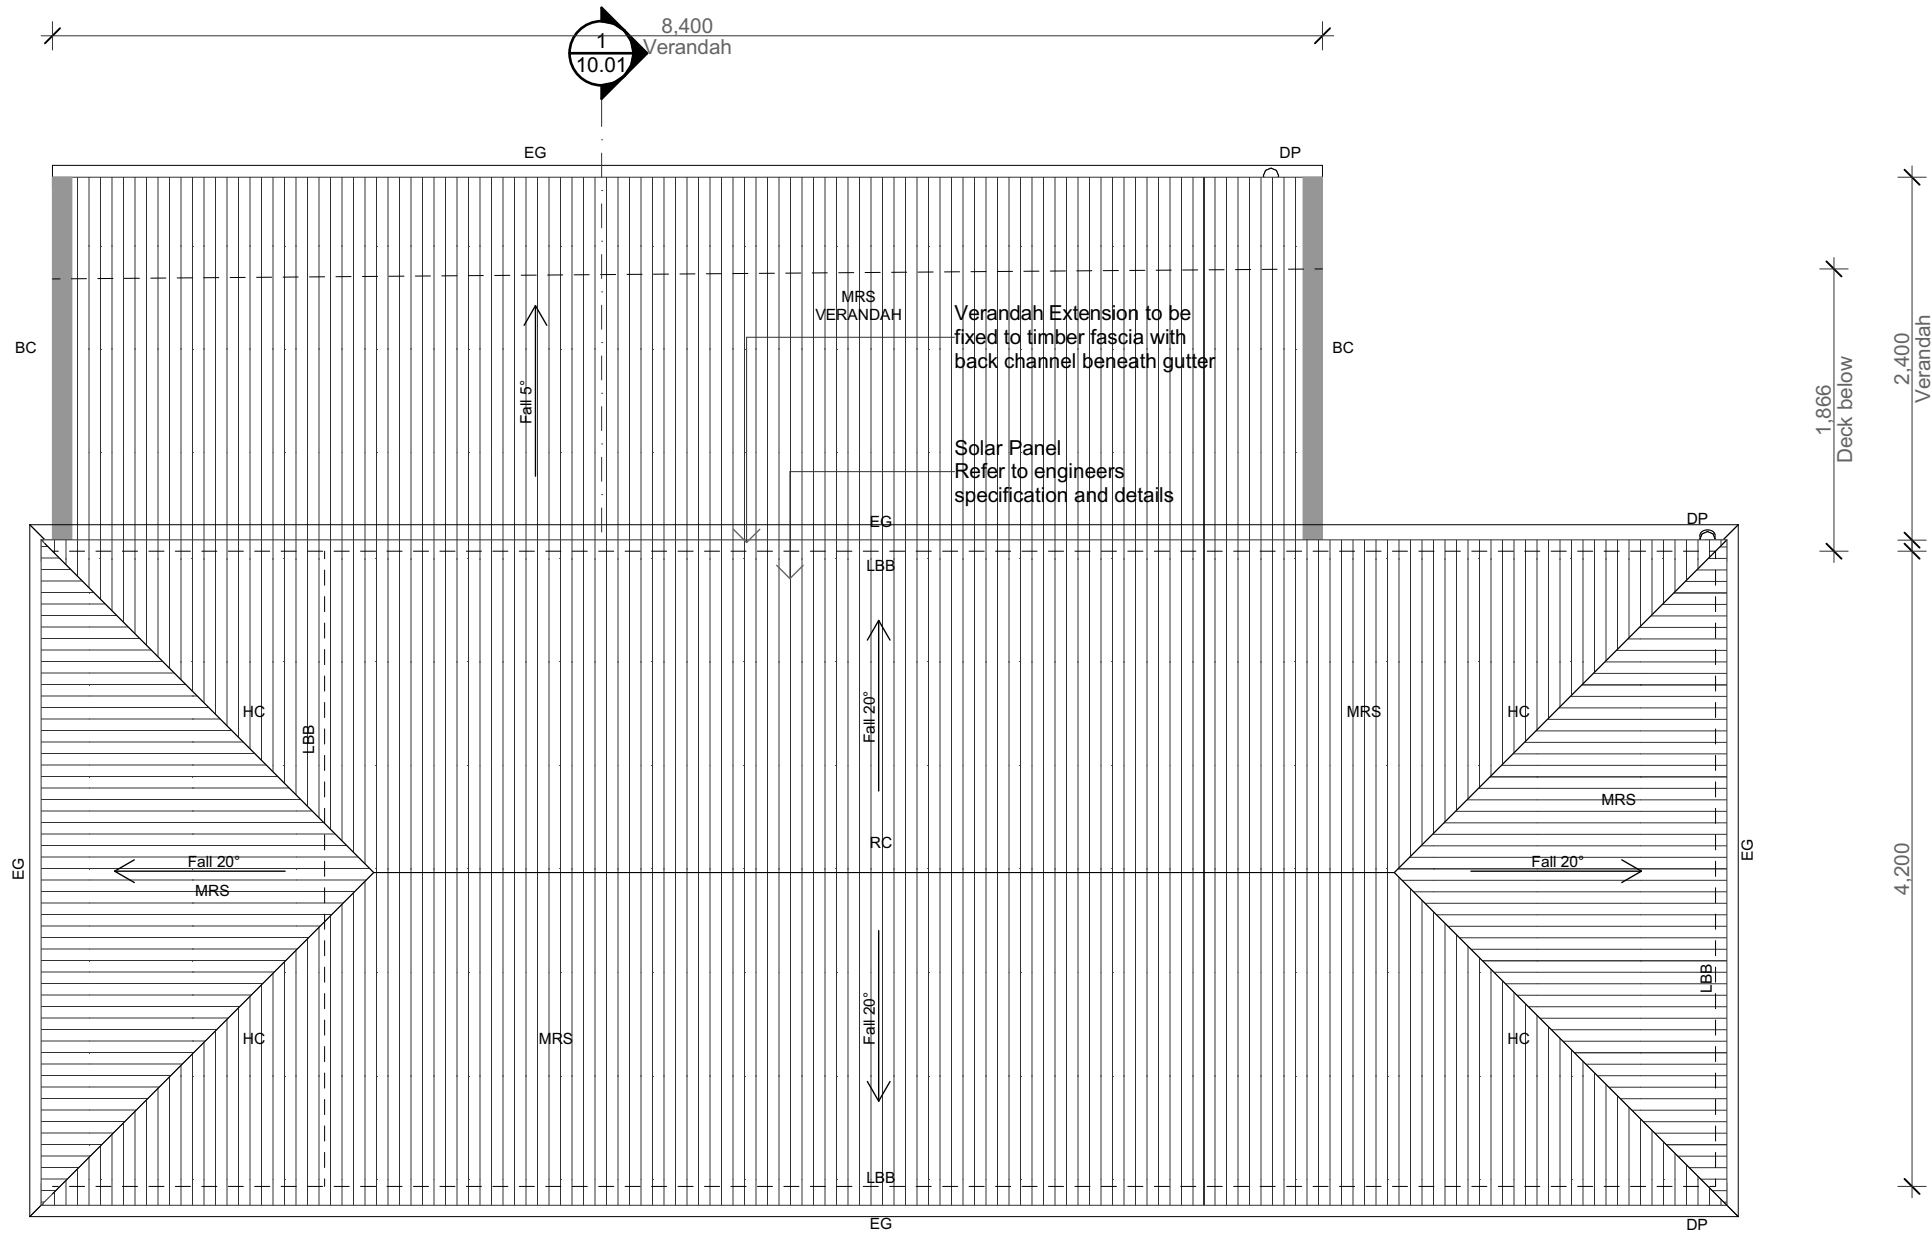

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09	The Banksia - Presentation Issue	6/08/2020
10	Preliminary	21/09/2020

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WINDOW SCHEDULE	
WINDOW NUMBER	TYPE
W-01	01
W-02	02
W-03	03
W-03	03
W-04	04
W-05	01
W-05	05

WINDOW TYPE LEGEND

TYPE

NOMINAL WxH SIZE

NOMINAL HEAD HEIGHT

QUANTITY

NOMINAL SILL HEIGHT




SYSTEM

FRAME FINISH

GLAZING

HARDWARE

OTHER

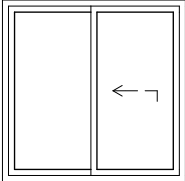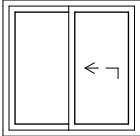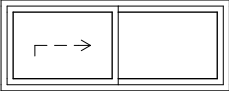01	02	03
1,210×1,200	910×900	1,510×600
2,100	2,100	2,100
2	1	2
		
900	1,200	1,500
Trend or Similar Approved	Trend or Similar Approved	Trend or Similar Approved
White Powdercoat Aluminium	White Powdercoat Aluminium	White Powdercoat Aluminium
Grey Glass	Grey Glass. Bathroom window to have obscure glass	Grey Glass
Provided by manufacturer	Provided by manufacturer	Provided by manufacturer
Allow for insect screen	Insect screen to all windows	Allow for insect screen

WINDOW TYPE LEGEND

TYPE

NOMINAL WxH SIZE

NOMINAL HEAD HEIGHT

QUANTITY

NOMINAL SILL HEIGHT



SYSTEM

FRAME FINISH

GLAZING

HARDWARE

OTHER

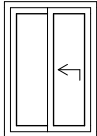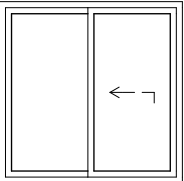04	05
610×900	1,210×1,200
2,100	2,100
1	1
	
1,200	900
Trend or Similar Approved	Trend or Similar Approved
White Powdercoat Aluminium	White Powdercoat Aluminium
Grey Glass. Bathroom window to have obscure glass	Grey Glass
Provided by manufacturer	Provided by manufacturer
Insect screen to all windows	Allow for insect screen

Window Schedule  
scale: @ A3

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drawn: PN

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A-WD-17.01




DOOR SCHEDULE	
DOOR NUMBER	TYPE
D-01	01
D-02	02
D-03	02
D-04	04
D-05	05


DOOR TYPE LEGEND  
TYPE  
NOMINAL WxH SIZE  
SILL/THRESHOLD  
QUANTITY

SYSTEM  
FRAME FINISH  
LEAF FINISH  
HARDWARE  
LOCKING / HANDLES  
OTHER

DOOR TYPE LEGEND  
TYPE  
NOMINAL WxH SIZE  
SILL/THRESHOLD  
QUANTITY

SYSTEM  
FRAME FINISH  
LEAF FINISH  
HARDWARE  
LOCKING / HANDLES  
OTHER

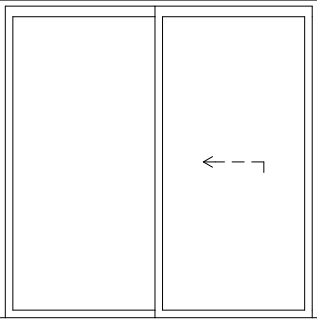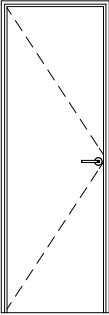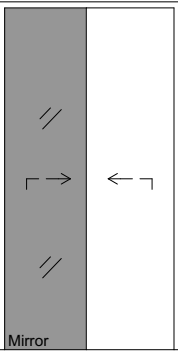
01	02	04
2,110×2,100	670×2,040	1,200×2,300
0	0	0
1	2	1
		
Trend or similar approved	Solid Core.	Vinyl Sliding Wadrobe Door
White Powdercoat Aluminium	White Architrave. Slam Jamb on hinge side.	Chrome frame
Glazed	White Paint Finish	Right leaf to be vinyl. Left leaf to be a mirror panel
Provided by supplier	Provided by supplier	Provided by supplier
Provided by supplier	Provided by supplier	Provided by supplier
Low profile frame. Provide for Crimsafe Security Screen as option		

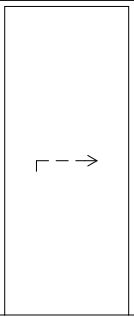05
820×2,040
0
1

Cavity Slider
White Paint Finish
White Paint Finish
Provided by supplier
Rectangular flush pull handle

Door Schedule  
scale: @ A3

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08	The Banksia - Review Issue	23/07/2020
09	Preliminary	21/09/2020

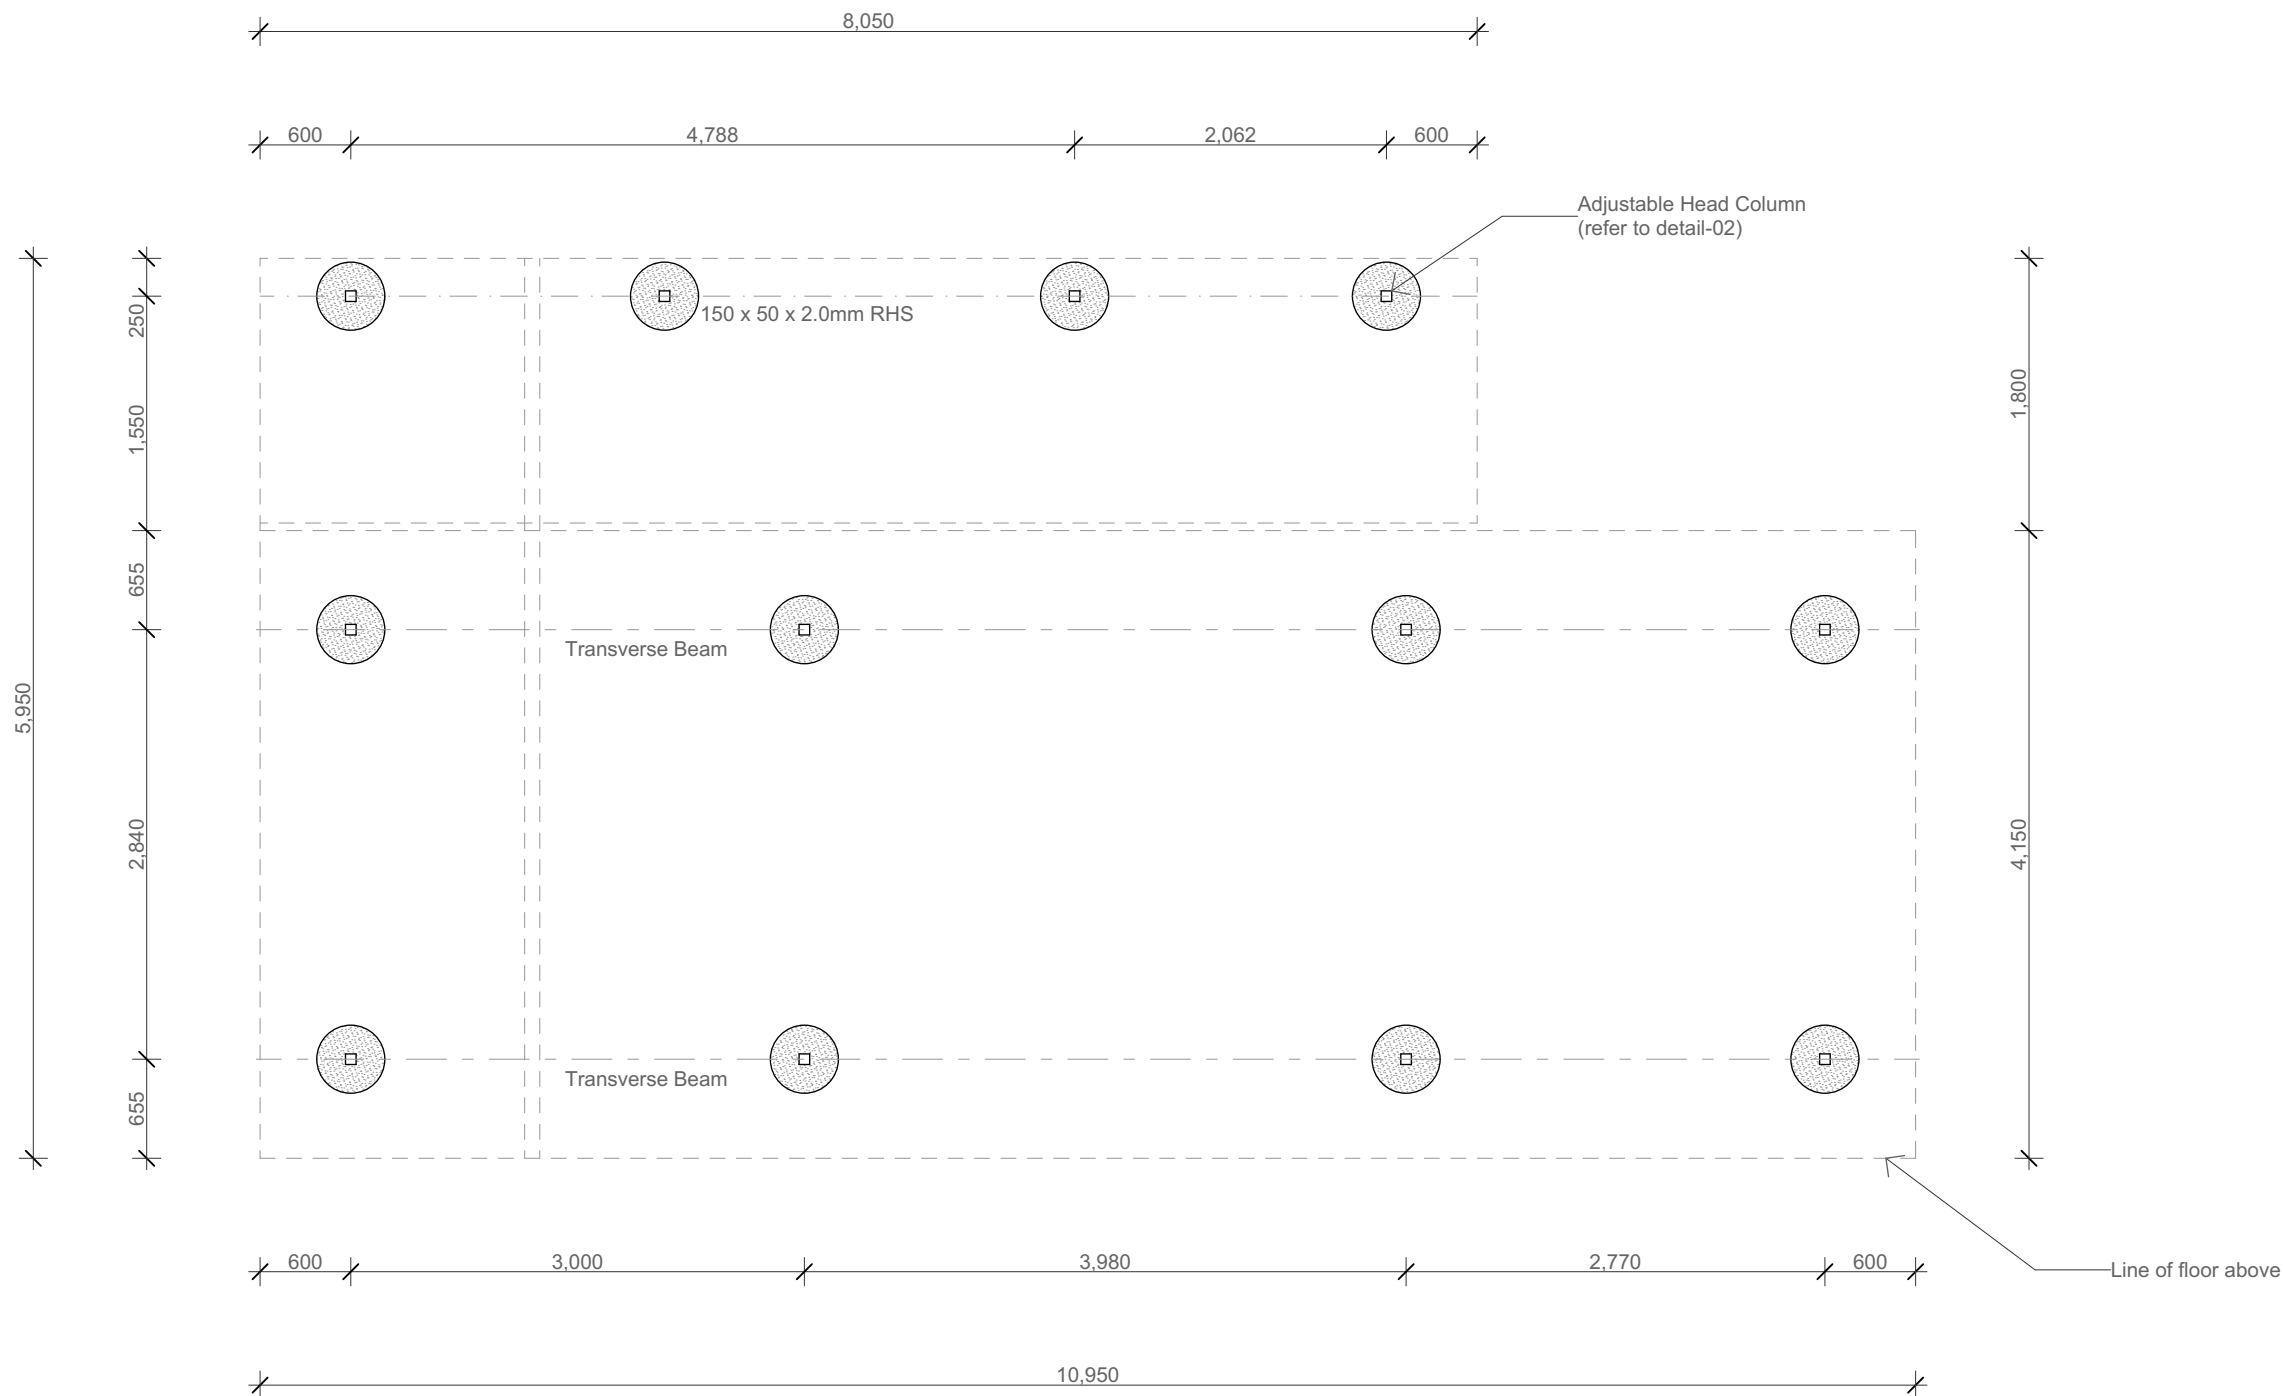
Figured dimensions take precedence over scale dimensions. Contractors must verify all dimensions on site before commencing any work or making shop drawings.



NOTES

High Set Sub Floor Structure  
100 x 100 x 4.0 RHS Galv. columns  
set into concrete footing, refer to detail.  
Pad footings comply with engineers  
detail and setout in accordance with  
footing plan as per design post to  
beam connection continuous fillet weld.

Soil class to be determined by  
engineer. Depth and adjustable heads  
to be provided as required depending  
on soil class. Refer to eng  
documentation in conjunction with AS  
2870-2011 for soil classification details

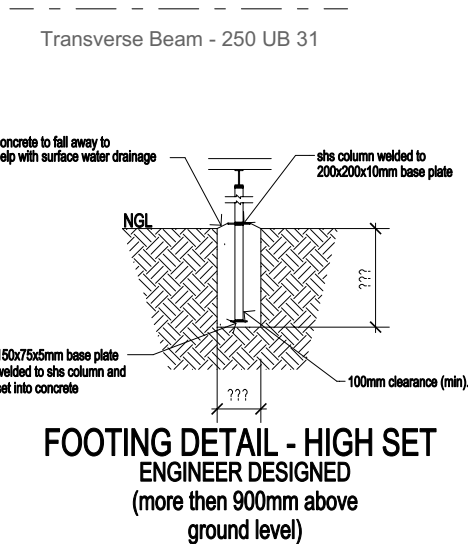

SOIL CLASSIFICATION AND FOOTING GUIDE

(to be read in conjunction with AS 2870-2011 and confirmed with engineer's documentation)

A - Option 1 - Rock close to surface, making excavation difficult and costly - 450 deep x 600 square or 600 dia. - Columns bolted to top of footing, reinforcement drilled and epoxy set into bedrock. (This option will need cross bracing, columns can't be used for bracing alone).  
- Option 2 - 750 deep x 450 dia - Steel Columns cast in 600mm min (300mm min. socket into rock).

S - 750 deep x 450 dia - Steel Columns cast in 600mm min.  
- 900 deep x 450 dia - Steel Columns cast in 750mm min.

M - 900 deep x 450 dia  
- Steel Columns cast in 750mm min.

H1 - 1200 deep x 450 dia  
- Steel Columns cast in 1000mm min.

H2 - 1500 deep x 450 dia  
- Steel Column cast in 1200mm min.  
- Steel Column cast in 750mm min. with 4/N12 bars +R6 Spiral Ties/Cage (full depth - cover)

E - 1800 deep x 450 dia - Columns to have Adjustable Heads to allow for movement/adjustments.  
- Steel Column cast in 1500mm min.  
- Steel Column cast in 750mm min. with 4/N12 bars +R6 Spiral Ties/Cage (full depth - cover)  
- Screw Piers with Steel Column (by others) Bracing Capacity of columns may be minimised - Generally allowance should be made for Cross Bracing.  
- Screw Piers (by others) with 900 deep x 450 dia pier top - Steel Columns cast in 750mm min. (Adjustable head potentially not required)

P - Site Specific

Stump & Footing Plan  
scale: 1:50 @ A3

Rev	Description	Date
03	The Banksia - Review Issue	23/07/2020
04	Preliminary	21/09/2020

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